
# **VICINITY MAP**

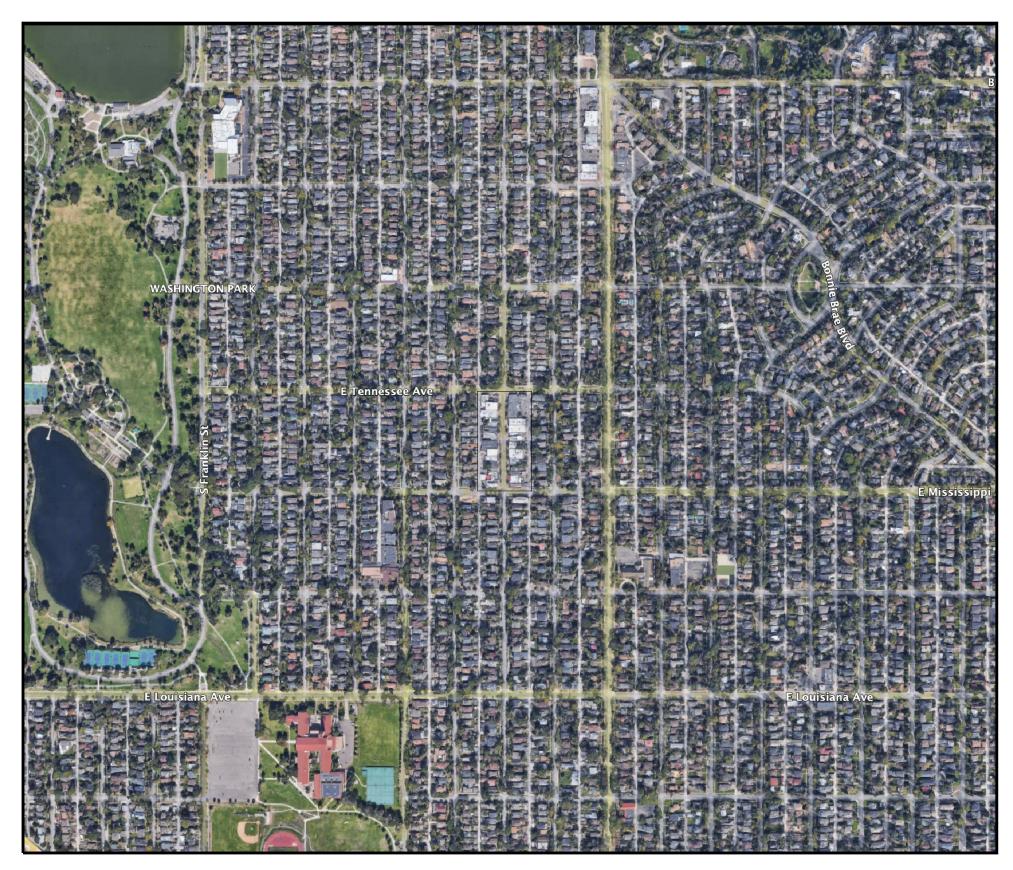

# **BRIEF**

This set of documents outlines the design intent for the addition of new planters along the 1000 S. Gaylord Street shopping corridor. All existing planters and trees are to remain undisturbed and shall be protected in accordance with best management practices throughout construction activities.

Select existing trees showing signs of disease or decline will be reviewed on-site with the client; any trees deemed necessary for removal will be identified and approved prior to any removal work.

# DRAWING SCHEDULE

SHEET INDEX COVER	SHEET # L0.0
SITE PLAN & EXISTING CONDITIONS	4
SITE PLAN DEMOLITION	L1.01
SITE PLANE PROPOSED	L1.02
SITE PLAN SOUTH	L1.1
SITE PLAN SOUTH CENTRAL	L1.2
SITE PLAN NORTH CENTRAL	L1.3
SITE PLAN NORTH	L1.4

# SITE AERIAL



# SCALE: NOT TO SCALE

### **General Notes**

- Site plan provided by HOA members of 1000 S. Gaylord Street.
- Builder will verify all existing site conditions, including the location of power lines, electric meters, gas lines, and other utilities prior to construction.
- All measurements and placement of planters to be verified in field (VIF).
- Due to the absence of a formal survey, the site plan was prepared using approximated measurements from Google Earth imagery; exact dimensions and locations to be confirmed during construction.
- Maintain a minimum 10' clearance between all new trees and existing wet utility lines (sewer, stormwater, water, etc.).
- No pedestrian lights are currently present on-site; lighting is provided primarily by streetlights.
- Electrical and plumbing connections will be provided at each newly installed planter.
- Client is advised to consult with the contractor of the existing planters regarding potential modifications or extensions to expand the planting area around existing trees.

..\..\.\\CloudDrive\Graphics\Tierra graphics\LOGO.JPG

TIERRA GARDEN CENTER LLC 801 WINONA CT. DENVER, CO 80204 PHONE: 720.938.3154

O S Gaylord Street
Denver, CO

SEAL

KEY PLAN

SCALE


DRAWN
APPROVED
CHECKED
DATE
TITLE


COVER

PROJECT NO.




LO.O

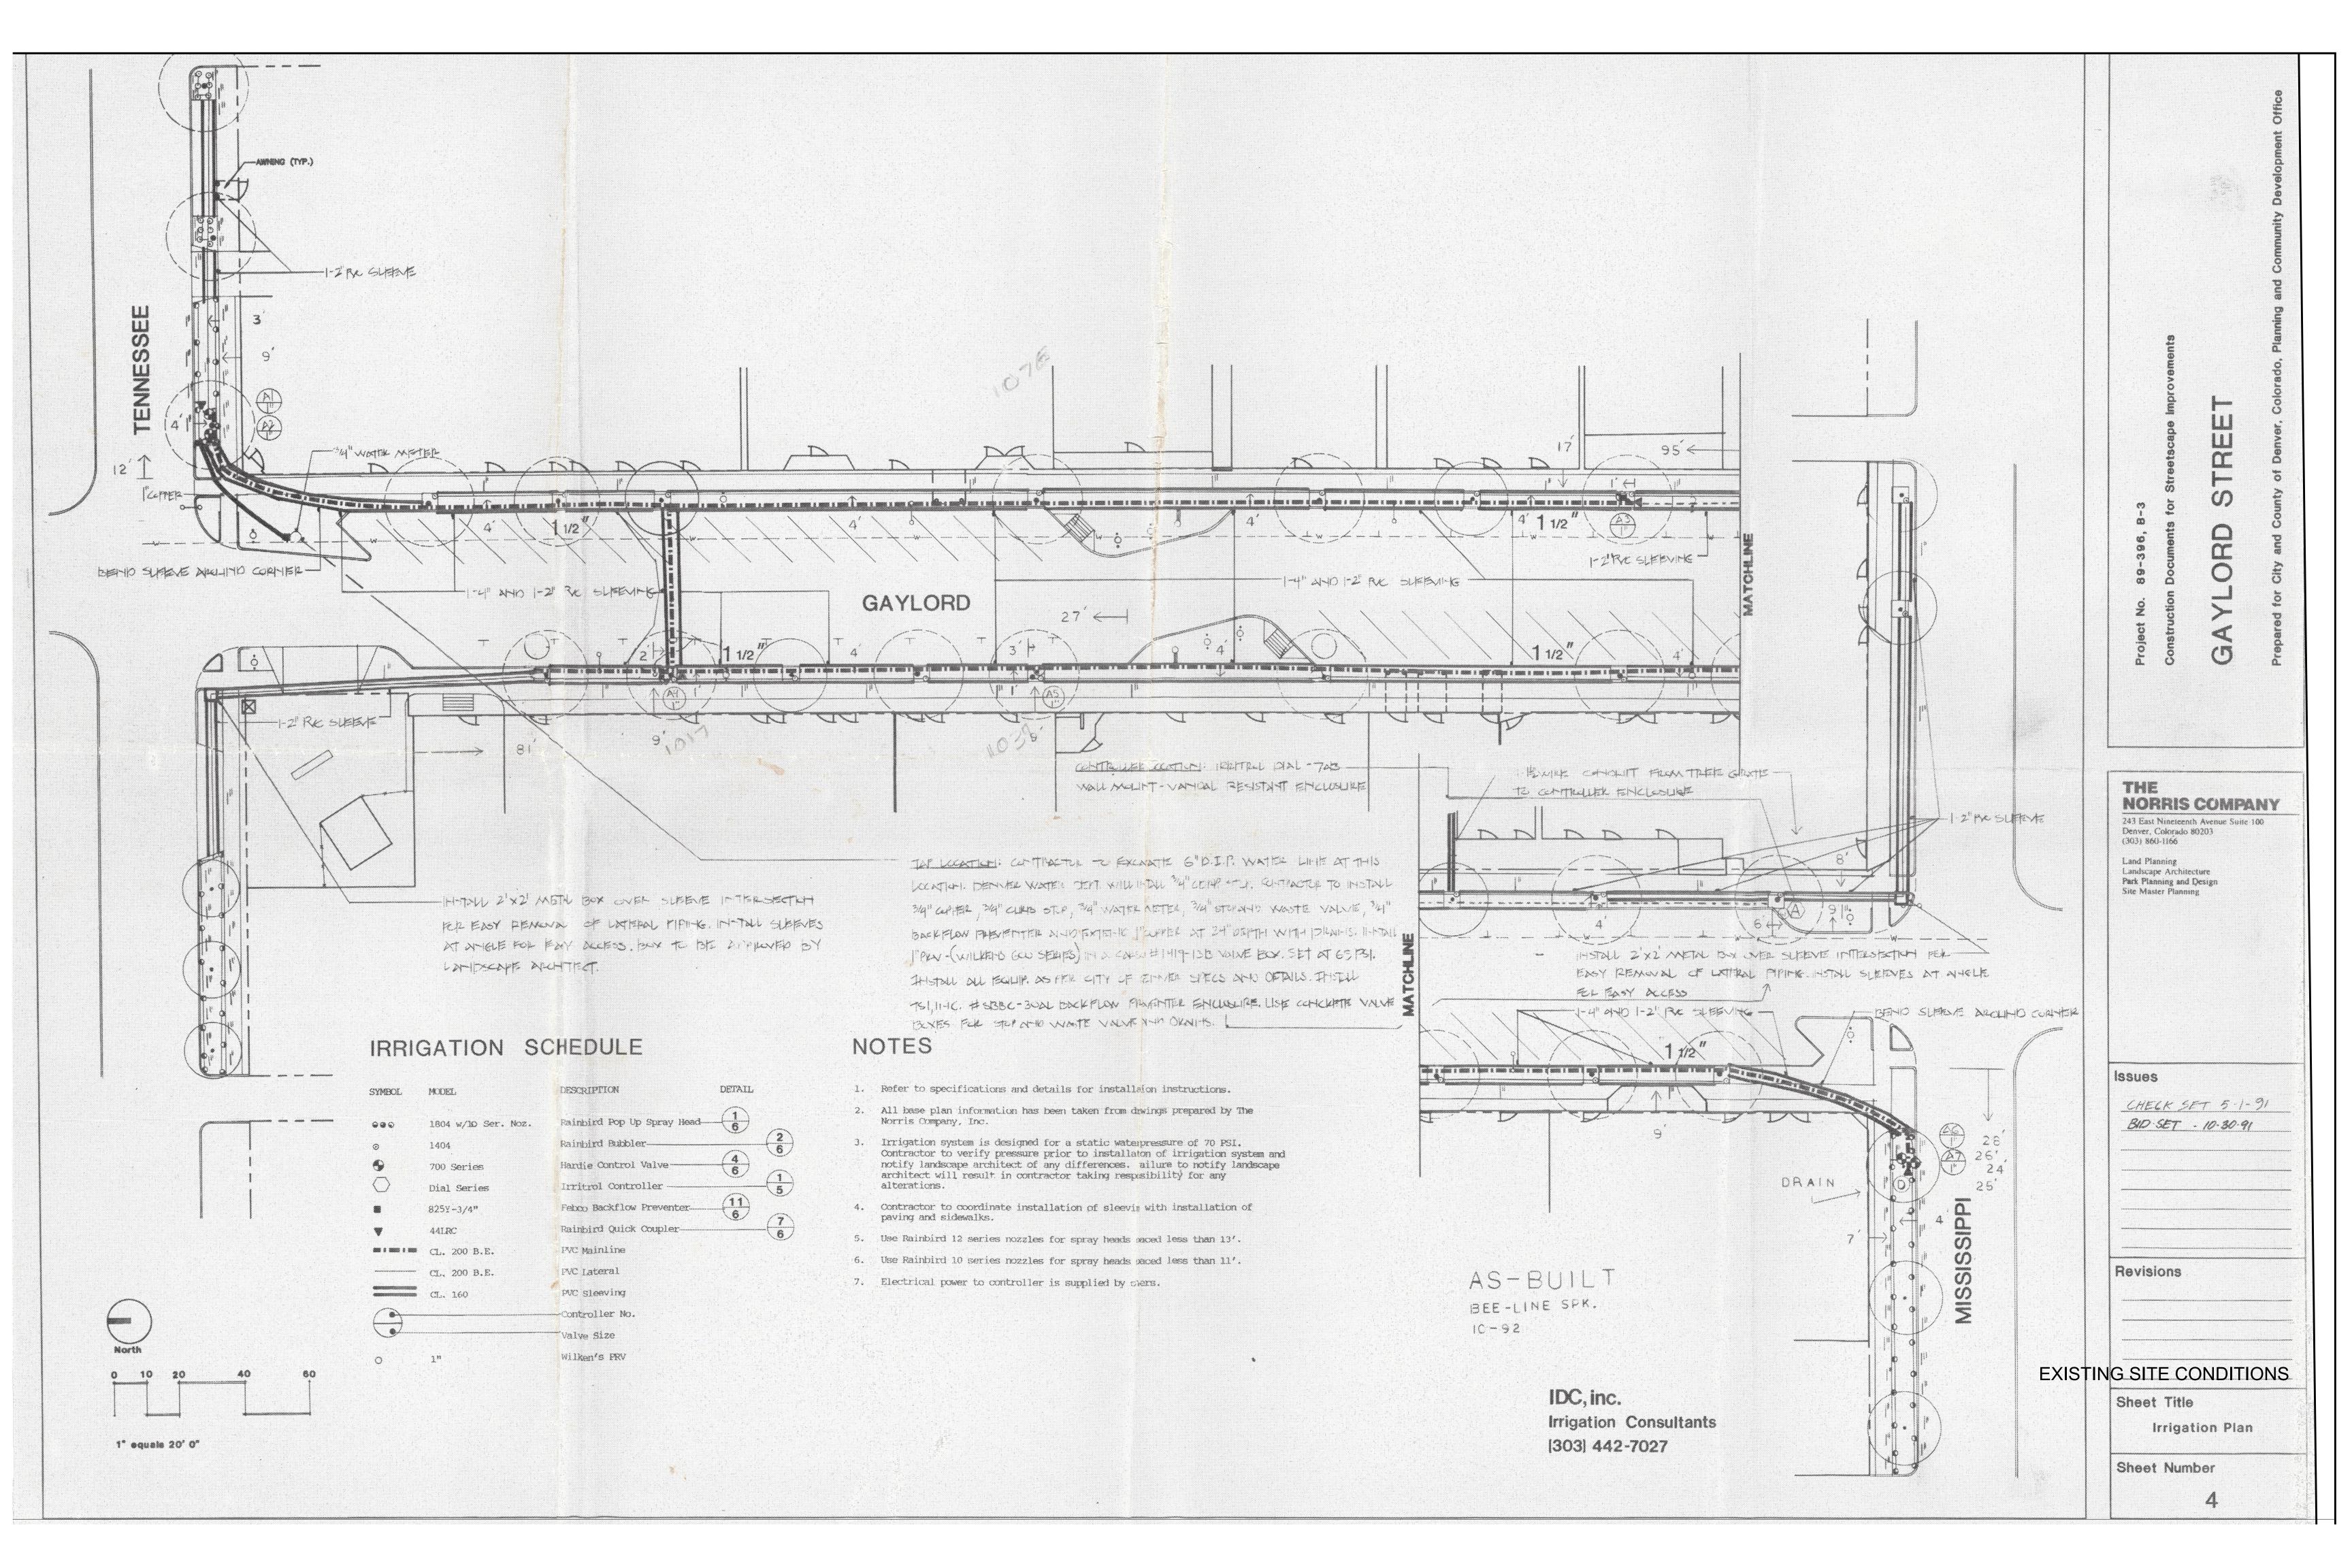

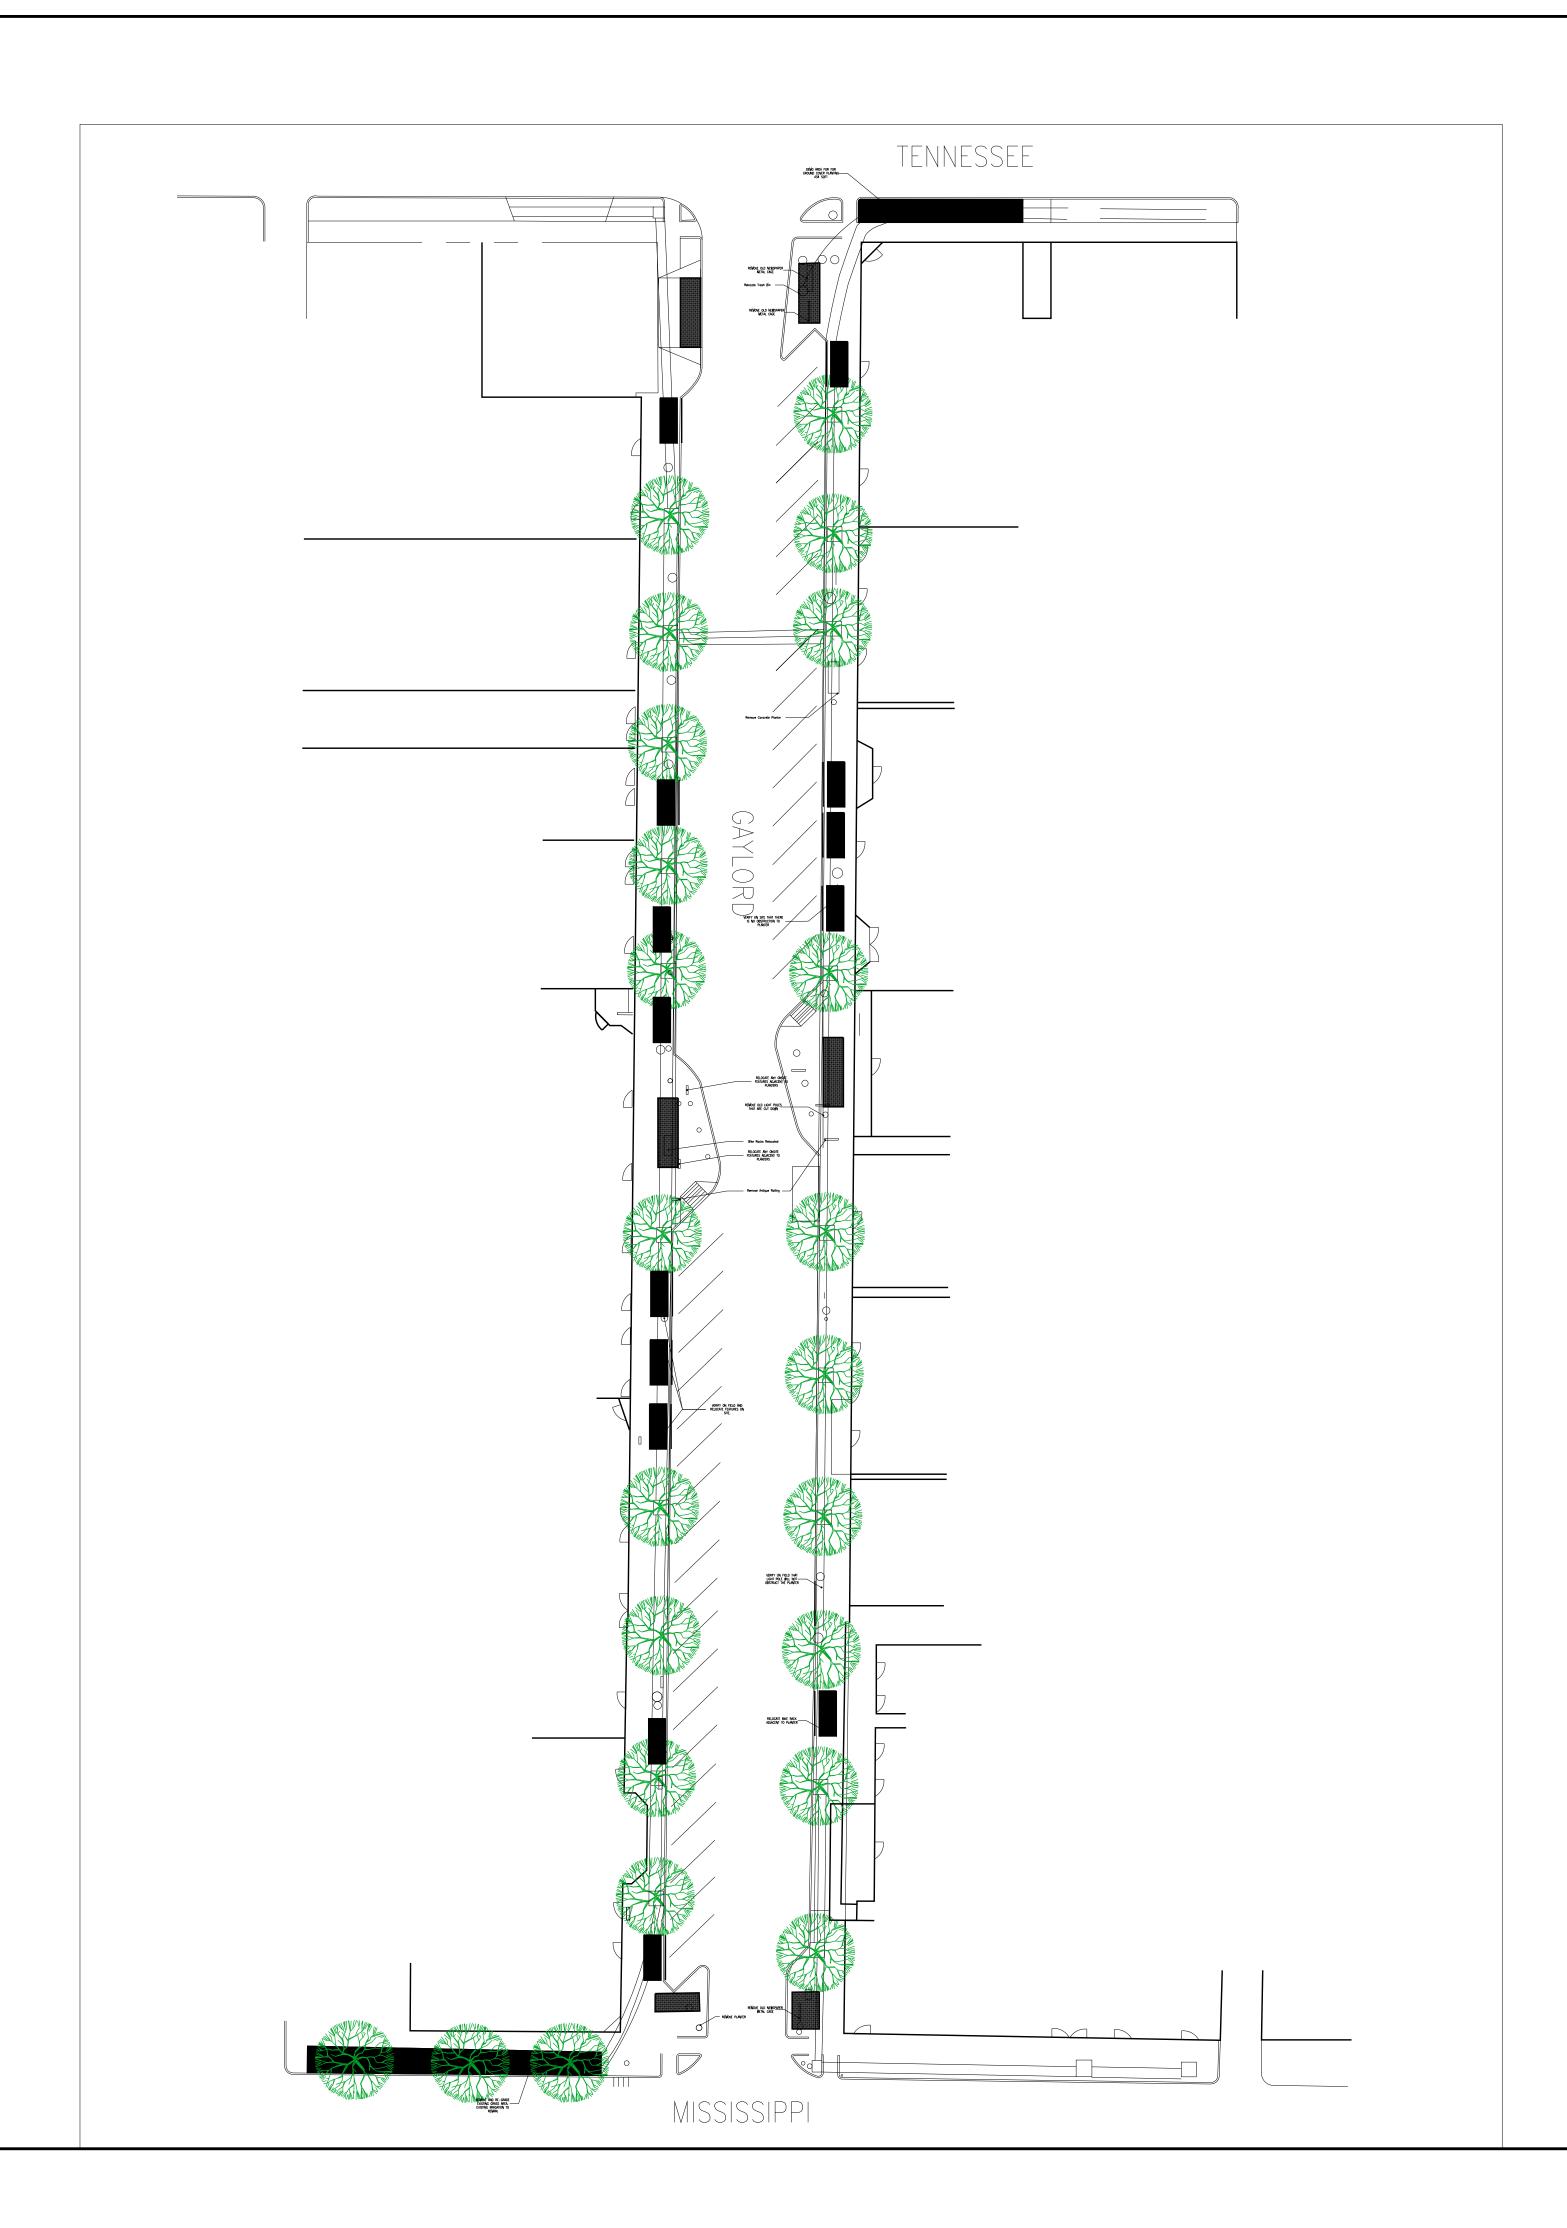

### **DEMOLITION KEY**

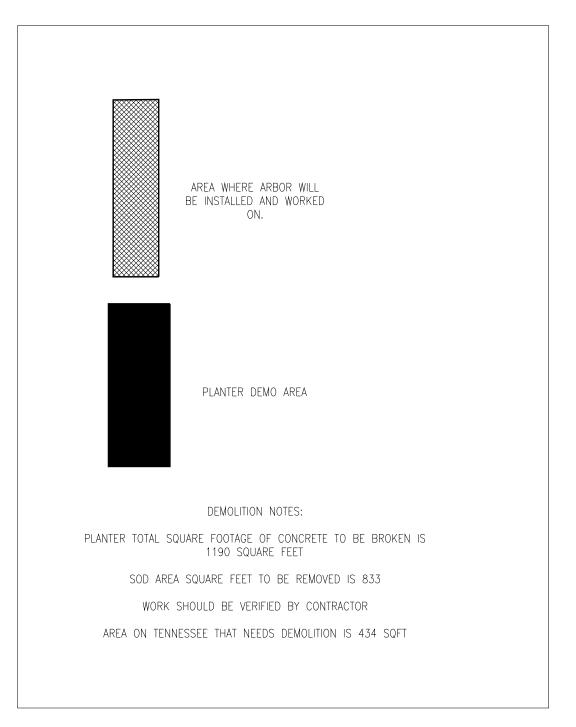

### General Notes

-ALL LANDSCAPE PLANS MUST BE APPROVED BY A GOVERNING BODY (CITY PLANNING, DRC, HOA, ETC.) IF APPLICABLE BEFORE CONSTRUCTION COMMENCES.

-ANY AND ALL APPLICATION / PERMITTING / LICENSING AND ANY ASSOCIATED FEES ARE THE RESPONSIBILITY OF THE OWNER. -ALL LANDSCAPED AREAS ARE TO BE AUTOMATICALLY IRRIGATED UNLESS PROHIBITED BY THE SOILS REPORT.

-AUTOMATIC IRRIGATION SYSTEM PROVIDED, WITH POP-UP SPRAYS AND ROTORS IN THE SOD AREAS, AND LOW-PRESSURE DRIP IRRIGATION FOR ALL PLANTING BEDS. RECOMMENDED THAT ALL SHRUBS AND PERENNIALS BE WATERED IN THOROUGHLY FOR ESTABLISHMENT, THEN CUT BACK TO SPECIES SPECIFIC PREFERRED WATERING SCHEDULES

-IRRIGATION SYSTEMS SHOULD NOT OPERATE BETWEEN 10:00A AND 5:00P, NOR DURING PERIODS OF SUSTAINED WINDS IN EXCESS OF 20MPH.

-ALL SOD AREAS TO BE KENTUCKY BLUE GRASS, IN SOD ROLL FORM. ALL SOD AREAS ARE TO RECEIVE TILLED ORGANIC MATERIAL AT 4CY/1000SF. -SHREDDED CEDAR MULCH, RIVER ROCK AND COBBLESTONE AREAS (MINIMUM OF 3" DEPTH, (COLORS SELECTED BY OWNER) ARE TO BE UNDER -LAID WITH WEED BARRIER FABRIC. RECOMMENDED THAT ALL MULCH BEDS BE TURNED AND PREPPED ONCE ANNUALLY -GALVANIZED STEEL EDGING WILL BE INSTALLED AS BARRIER IN-BETWEEN SOD AND PLANTING BED AREAS. THE EDGING WILL BE SECURED WITH STEEL EDGING STAKES PENETRATING GRADE FOR SAFETY, AND INCLUDE PLASTIC SAFETY CAP OR ROLL-TOP.

-POSITIVE DRAINAGE AWAY FROM BUILDING FOUNDATION TO REMAIN - A MINIMUM 2% SLOPE IN BOTH SOFT AND HARD-SCAPE APPLICATIONS. ANY GRADE FOUND NOT TO BE WITHIN

THESE MINIMUMS WILL BE THE RESPONSIBILITY OF THE OWNER.

- ALL RETAINING WALLS OVER 4 ARE TO BE ENGINEERED FOR PROPER WEIGHT LOAD DISTRIBUTION. ARE TO BE

ENGINEERED FOR PROPER WEIGHT LOAD DISTRIBUTION.

-ALL PLANTING AND SEEDING TO BE COMPLETED DURING THE ACTIVE GROWING SEASON, NOT DURING INCLEMENT OR FREEZING WEATHER.

-SOIL AMENDMENTS ARE REQUIRED FOR ALL PLANTED AREAS. ALL PLANT MATERIAL SHALL BE BACKFILLED WITH ONE PART COMPOST MIXTURE, TWO PARTS NATIVE TOPSOIL UPON AVAILABILITY.

-PLANTING MATERIAL TO BE NURSERY GROWN AND UP TO ANY AND ALL COLORADO PLANTING REGULATIONS OR GUIDELINES. -PLANTING MATERIAL DESIGN AND LAYOUT IS MERELY SUGGESTIVE, SPECIFIC VARIETIES, SPECIMENS, AND QUANTITIES TO BE DETERMINED DURING THE INSTALLATION PROCESS ACCORDING TO NURSERY STOCK AND

-BMP AND ALCA GUIDELINES FOR PROPER SELECTION, INSTALLATION AND MAINTENANCE ARE TO BE NOTED AND FOLLOWED DURING CONSTRUCTION. -ANY ELECTRICAL / PLUMBING / GAS / FENCING / CONCRETE / DECK OR OTHER CONTRACTING REQUIRED FOR LANDSCAPE CONSTRUCTION WILL BE THE RESPONSIBILITY OF THE OWNER. -LANDSCAPE CONTRACTOR IS RESPONSIBLE FOR LOCATION AND PRESERVATION OF ALL EXISTING UTILITIES PRIOR TO BEGINNING WORK. CALL BEFORE YOU DIG: 1-800-922-1987.

-LANDSCAPE CONTRACTOR IS RESPONSIBLE FOR FIELD VERIFYING ALL SITE CONDITIONS BEFORE BIDDING TO DETERMINE SCOPE OF WORK.

-ALL UTILITY EASEMENTS AND EMERGENCY ACCESSES SHALL REMAIN UNOBSTRUCTED AND FULLY ACCESSIBLE ALONG THEIR ENTIRE LENGTH FOR MAINTENANCE AND EMERGENCY EQUIPMENT AND VEHICLES.

..\..\.\iCloudDrive\Graphics\Tierra graphics\LOGO.JPG

TIERRA GARDEN CENTER LLC 801 WINONA CT. DENVER, CO 80204 PHONE: 720.938.3154

000 S Gaylord Street
Denver, CO

KEY PLAN

\_\_\_

SCALE

 $\frac{1}{32}$ "=1

DRAWN APPROVED CHECKED

DATE

SITE PLAN DEMOLITION

PROJECT NO.

L1.01

SHEET NO.



# MISSISSIPPI


### TREE SELECTION

	пО	RSE CHESTNUT	TREE / SAPINDACE	AE	
SIZE	HEIGHT	WIDTH	SEASON OF INTEREST	CONDITION	QUANTI
2.5"	40'	40	LATE SPRING	FULL SUN/PARTIAL SUN	4
	A	MERICAN LINDE	EN / TILIA AMERICAN	N	
SIZE	HEIGHT	WIDTH	SEASON OF INTEREST	CONDITION	QUANTI
2.5"	50'	30'	LATE SPRING	FULL SUN	3
		RED OAK / Q	UARCUS RUBRA	-	
SIZE	HEIGHT	WIDTH	SEASON OF INTEREST	CONDITION	QUANTI
2.5"	60'	40'	FALL	FULL SUN	6
	KENTU	JCKY COFFEE /	GYMNOCLADUS DIG	DICUS	
			SEASON OF	CONDITION	QUANTI
SIZE	HEIGHT	WIDTH	INTEREST	CONDITION	QUAINTI

### PLANT SELECTION

	BEACH STRAWBERRY/ FRAGARIA CHILOENSIS						
SIZE	HEIGHT	WIDTH	SEASON OF INTEREST	CONDITION	QUANTITY		
F32	4"	6"	EVERGREEN	FULL SUN	290		

### PLANTER DETAILS:

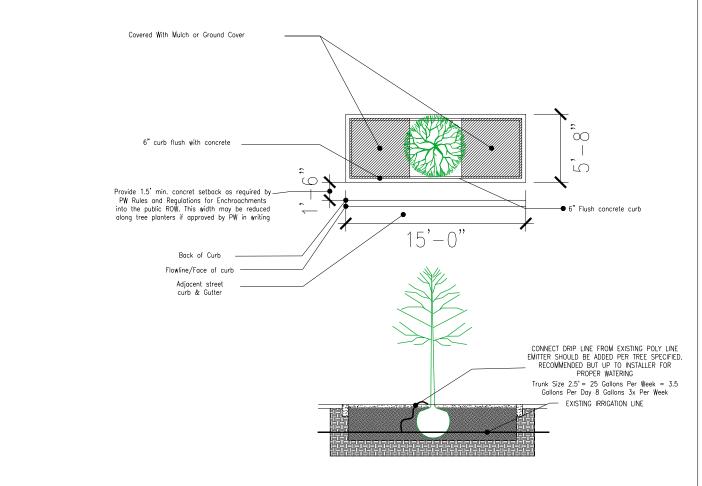

Planter Notes:
Electrical shall be Extended to planters as well.
No Grates will be used for planters.
They will be substituted with mulch or ground cover

TREE MANAGEMENT AND PLANTING AREA EXPANSION NOTES

Specific trees designated for removal and replacement include:

1091 S. Gaylord Street - (3) Ash trees along E. Mississippi

succession planting between existing trees over time.

Amend soil to the original grade prior to excavation.

1080 S. Gaylord Street —(1) Honeylocust 1076 S. Gaylord Street —(1) Honeylocust

minimum width standards.

for root exploration.

Planting Pit Expansion Procedure:

expose the root flare above grade.

(sewer, storm, water, etc.).

Minimum 25' from streetlights

requirements, especially near patio areas.

utilities such as irrigation lines will not be marked.

Minimum 10'-15' from pedestrian light poles

A canopy succession plan shall be implemented for 1000 S. Gaylord Street, utilizing a phased strategy of removal/replacement, planting pit expansion, and

Expansion of existing 5'x5' tree pits shall be conducted where feasible, ensuring

Remove concrete paving by hand to minimize root damage; limit mechanical

Fill any grade differences with shredded redwood mulch only; rock, breeze, decomposed granite, and cobble are prohibited within the public ROW.

Maintain a minimum 10' separation between new trees and all wet utilities

Maintain appropriate clearances from overhead and pedestrian lighting:

Where soil has accumulated against existing tree trunks, manually remove to

Succession planting may allow reduced spacing between existing and new trees when appropriate, while maintaining compliance with PAR width and clear path

Utility locations must be verified by submitting a locate request to 811; private

Excavate newly exposed areas to a depth of 4"-6" using pneumatic excavation

no conflicts with the required Public Access Route (PAR) continuity and

SCALE  $\frac{1}{8}$ " = 1'

### General Notes

-ALL LANDSCAPE PLANS MUST BE APPROVED BY A GOVERNING BODY (CITY PLANNING, DRC, HOA, ETC.) IF APPLICABLE BEFORE CONSTRUCTION COMMENCES.

-ANY AND ALL APPLICATION / PERMITTING / LICENSING AND ANY ASSOCIATED FEES ARE THE RESPONSIBILITY OF THE OWNER. -ALL LANDSCAPED AREAS ARE TO BE AUTOMATICALLY IRRIGATED UNLESS PROHIBITED BY THE SOILS REPORT.

-AUTOMATIC IRRIGATION SYSTEM PROVIDED, WITH POP-UP SPRAYS AND ROTORS IN THE SOD AREAS, AND LOW-PRESSURE DRIP IRRIGATION FOR ALL PLANTING BEDS. RECOMMENDED THAT ALL SHRUBS AND PERENNIALS BE WATERED IN THOROUGHLY FOR ESTABLISHMENT, THEN CUT BACK TO SPECIES SPECIFIC PREFERRED WATERING SCHEDULES.

-IRRIGATION SYSTEMS SHOULD NOT OPERATE BETWEEN 10:00A AND 5:00P, NOR DURING PERIODS OF SUSTAINED WINDS IN EXCESS OF 20MPH.

-ALL SOD AREAS TO BE KENTUCKY BLUE GRASS, IN SOD ROLL FORM. ALL SOD AREAS ARE TO RECEIVE TILLED ORGANIC MATERIAL AT 4CY/1000SF. -SHREDDED CEDAR MULCH, RIVER ROCK AND COBBLESTONE AREAS (MINIMUM OF 3" DEPTH, (COLORS SELECTED BY OWNER) ARE TO BE UNDER -LAID WITH WEED BARRIER FABRIC. RECOMMENDED THAT ALL MULCH BEDS BE TURNED AND PREPPED ONCE ANNUALLY -GALVANIZED STEEL EDGING WILL BE INSTALLED AS BARRIER IN-BETWEEN SOD AND PLANTING BED AREAS. THE EDGING WILL BE SECURED WITH STEEL EDGING STAKES PENETRATING GRADE FOR SAFETY, AND INCLUDE PLASTIC SAFETY CAP OR ROLL-TOP.
-POSITIVE DRAINAGE AWAY FROM BUILDING FOUNDATION TO REMAIN

- A MINIMUM 2% SLOPE IN BOTH SOFT AND HARD-SCAPE APPLICATIONS. ANY GRADE FOUND NOT TO BE WITHIN THESE MINIMUMS WILL BE THE RESPONSIBILITY OF THE OWNER.

-ALL RETAINING WALLS OVER 4 ARE TO BE ENGINEERED FOR PROPER WEIGHT LOAD DISTRIBUTION. ARE TO BE ENGINEERED FOR PROPER WEIGHT LOAD DISTRIBUTION.

-ALL PLANTING AND SEEDING TO BE COMPLETED DURING THE ACTIVE GROWING SEASON, NOT DURING INCLEMENT OR FREEZING WEATHER.

-SOIL AMENDMENTS ARE REQUIRED FOR ALL PLANTED AREAS. ALL PLANT MATERIAL SHALL BE BACKFILLED WITH ONE PART COMPOST MIXTURE, TWO PARTS NATIVE TOPSOIL UPON AVAILABILITY.
-PLANTING MATERIAL TO BE NURSERY GROWN AND UP TO ANY AND ALL COLORADO PLANTING REGULATIONS OR GUIDELINES.
-PLANTING MATERIAL DESIGN AND LAYOUT IS MERELY SUGGESTIVE. SPECIFIC VARIETIES. SPECIMENS.

GUIDELINES. -PLANTING MATERIAL DESIGN AND LAYOUT IS MERELY SUGGESTIVE, SPECIFIC VARIETIES, SPECIMENS, AND QUANTITIES TO BE DETERMINED DURING THE INSTALLATION PROCESS ACCORDING TO NURSERY STOCK AND AVAILABILITY.

-BMP AND ALCA GUIDELINES FOR PROPER SELECTION, INSTALLATION AND MAINTENANCE ARE TO BE NOTED AND

-BMP AND ALCA GUIDELINES FOR PROPER SELECTION, INSTALLATION AND MAINTENANCE ARE TO BE NOTED AND FOLLOWED DURING CONSTRUCTION. -ANY ELECTRICAL / PLUMBING / GAS / FENCING / CONCRETE / DECK OR OTHER CONTRACTING REQUIRED FOR LANDSCAPE CONSTRUCTION WILL BE THE RESPONSIBILITY OF THE OWNER. -LANDSCAPE CONTRACTOR IS RESPONSIBLE FOR LOCATION AND PRESERVATION OF ALL EXISTING UTILITIES PRIOR TO BEGINNING WORK. CALL BEFORE YOU DIG: 1-800-922-1987.

-LANDSCAPE CONTRACTOR IS RESPONSIBLE FOR FIELD VERIFYING ALL SITE CONDITIONS BEFORE BIDDING TO DETERMINE SCOPE OF WORK.

-ALL UTILITY EASEMENTS AND EMERGENCY ACCESSES SHALL REMAIN UNOBSTRUCTED AND FULLY ACCESSIBLE ALONG THEIR ENTIRE LENGTH FOR MAINTENANCE AND EMERGENCY EQUIPMENT AND VEHICLES.

..\.\.\\CloudDrive\Graphics\Tierra graphics\LOGO.JPG

TIERRA GARDEN CENTER LLC 801 WINONA CT. DENVER, CO 80204 PHONE: 720.938.3154

000 S Gaylord Street
Denver, CO

SEAL

KEY PLAN

SCALE

 $\frac{1}{32}$ "=1

DRAWN APPROVED CHECKED

DATE


SITE PLAN PROPOSED

PROJECT NO.


SHEET NO.

L1.02



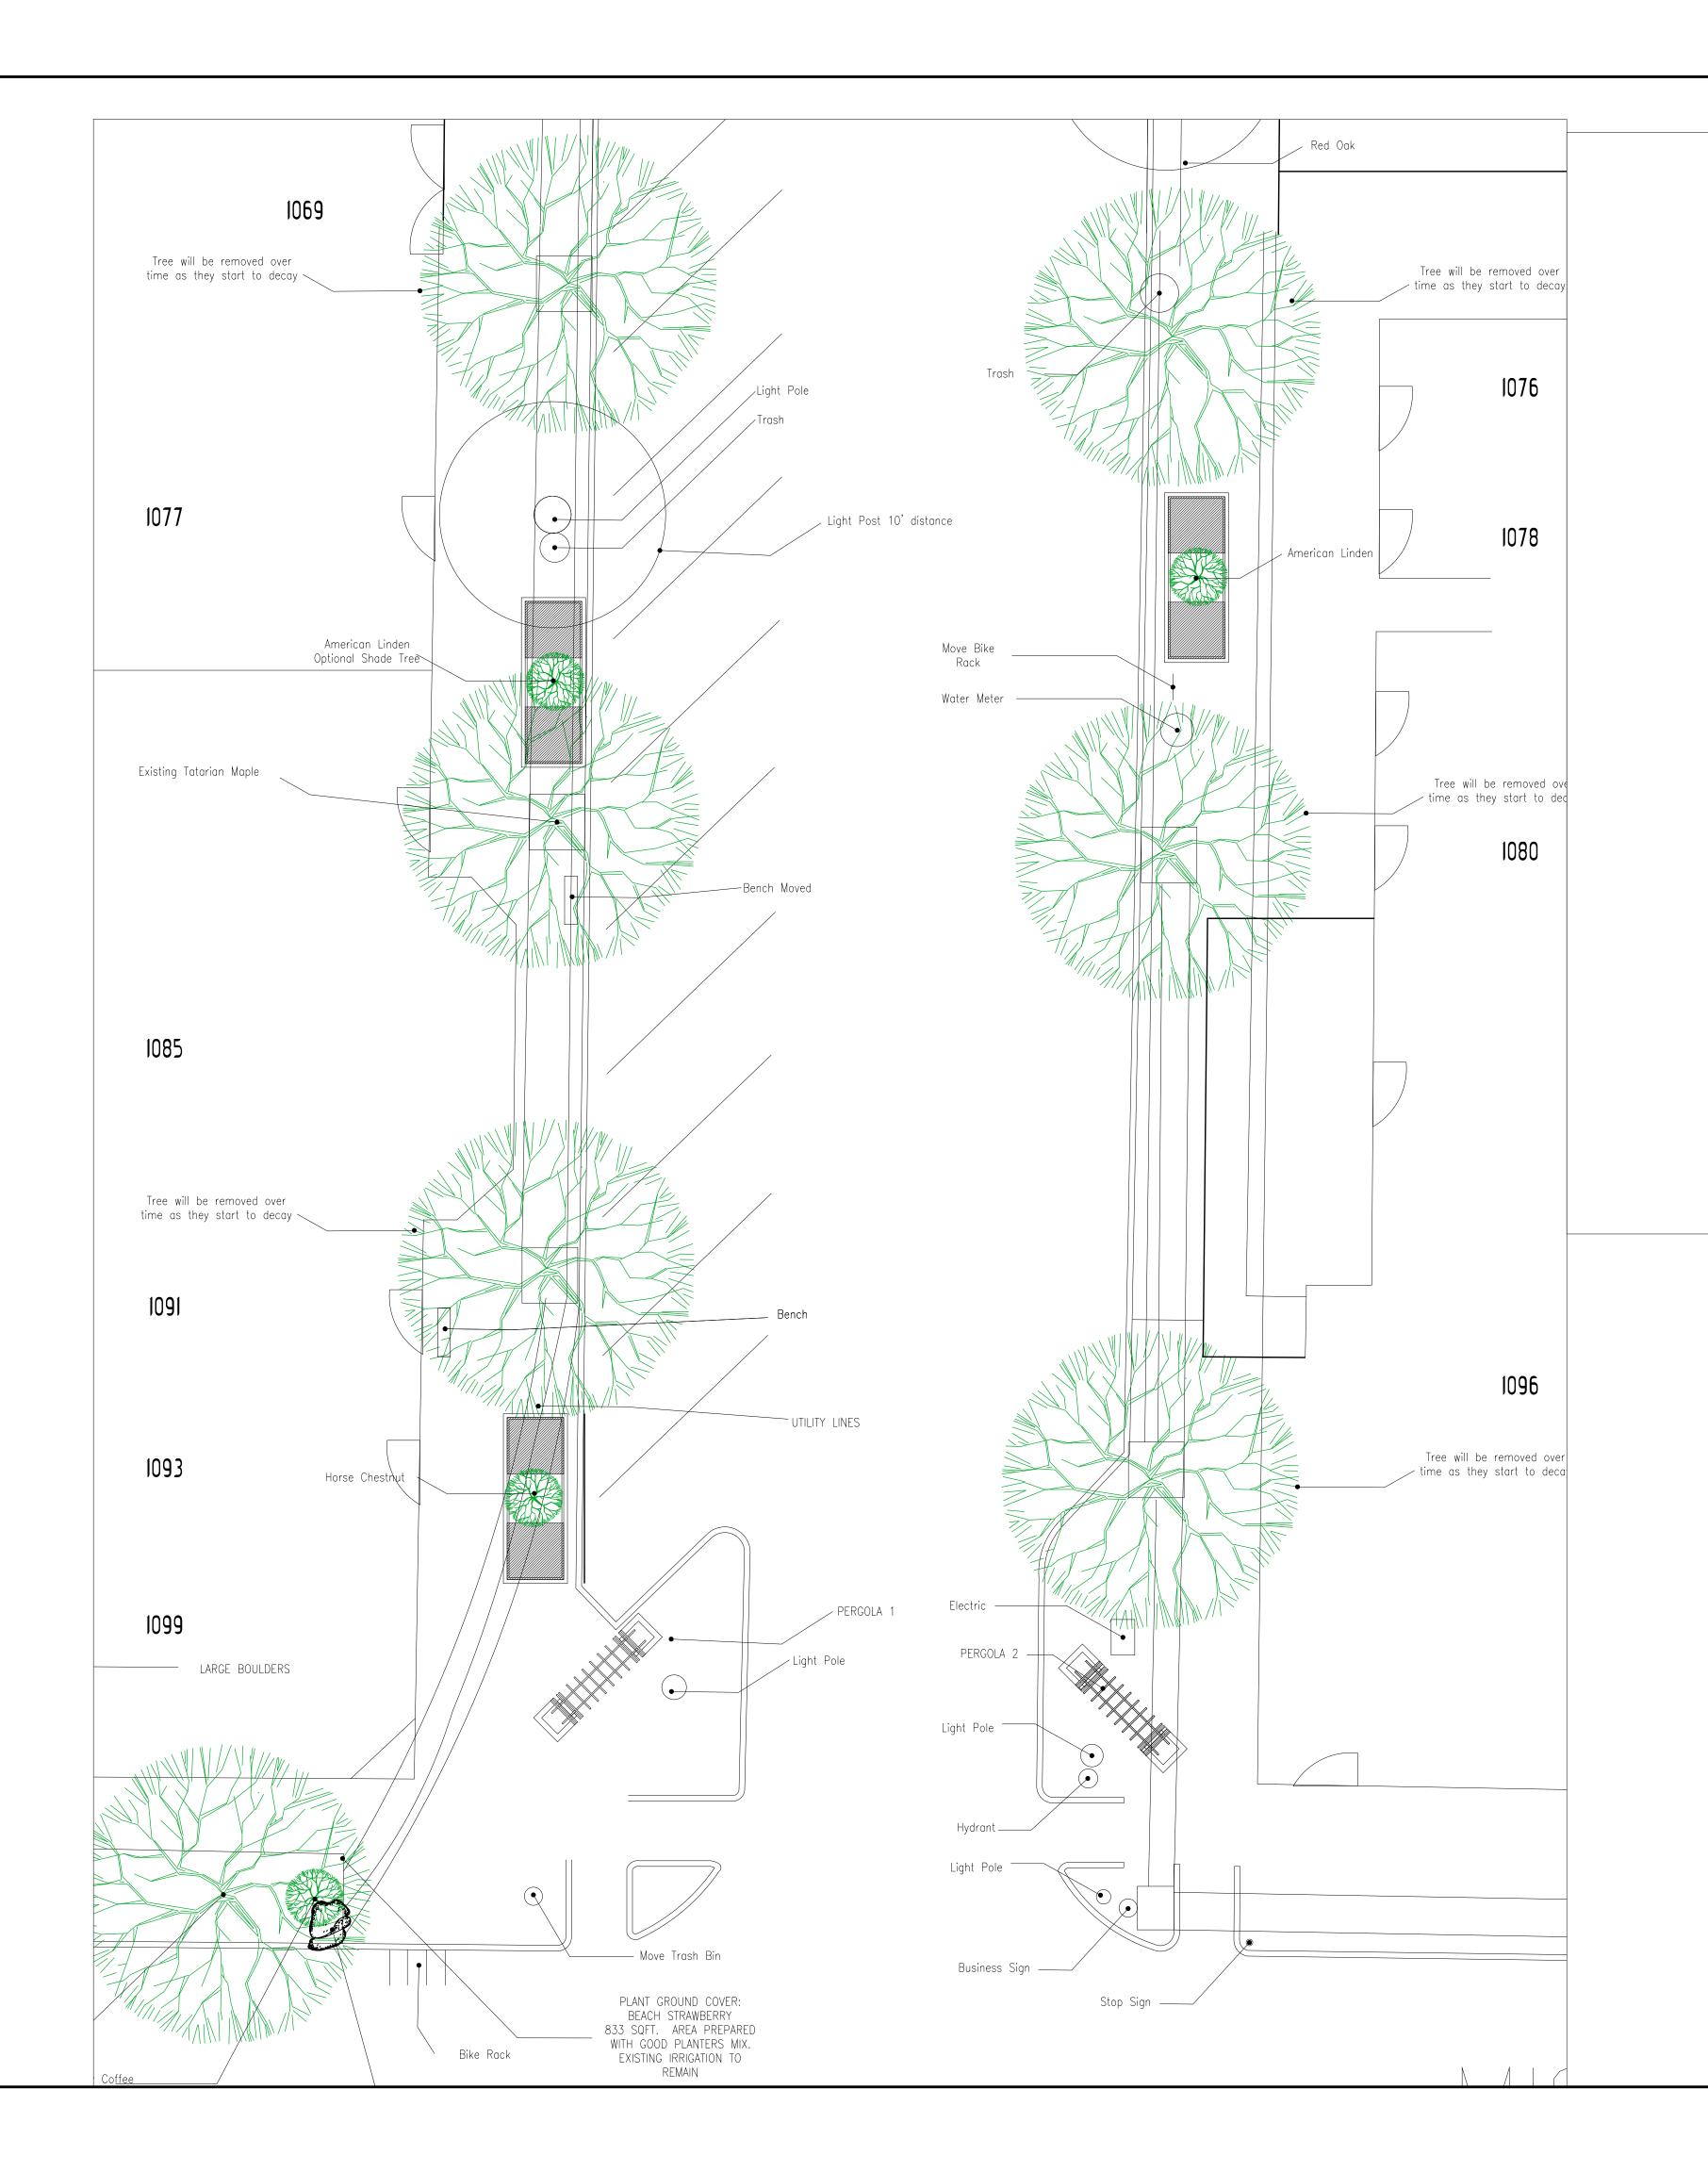

### PLANTER DETAILS

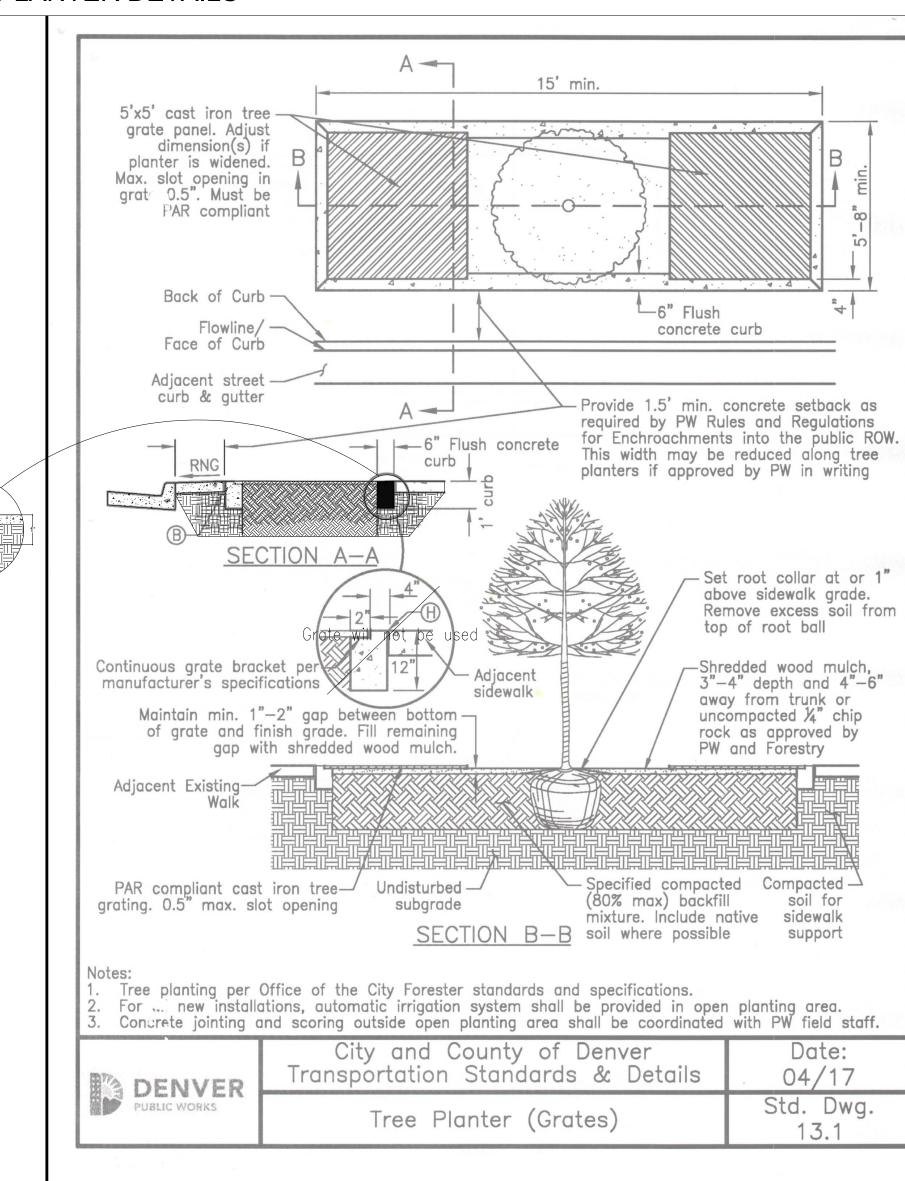

# **General Notes**

-ALL LANDSCAPE PLANS MUST BE APPROVED BY A GOVERNING BODY (CITY PLANNING, DRC, HOA, ETC.) IF APPLICABLE BEFORE CONSTRUCTION COMMENCES.

-ANY AND ALL APPLICATION / PERMITTING / LICENSING AND ANY ASSOCIATED FEES ARE THE RESPONSIBILITY OF THE OWNER. - ALL LANDSCAPED AREAS ARE TO BE AUTOMATICALLY IRRIGATED UNLESS PROHIBITED BY THE SOILS REPORT.

-AUTOMATIC IRRIGATION SYSTEM PROVIDED, WITH POP-UP SPRAYS AND ROTORS IN THE SOD AREAS, AND LOW-PRESSURE DRIP IRRIGATION FOR ALL PLANTING BEDS. RECOMMENDED THAT ALL SHRUBS AND PERENNIALS BE WATERED IN THOROUGHLY FOR ESTABLISHMENT, THEN CUT BACK TO SPECIES SPECIFIC PREFERRED WATERING

-IRRIGATION SYSTEMS SHOULD NOT OPERATE BETWEEN 10:00A AND 5:00P, NOR DURING PERIODS OF SUSTAINED WINDS IN EXCESS OF 20MPH.

-ALL SOD AREAS TO BE KENTUCKY BLUE GRASS, IN SOD ROLL FORM. ALL SOD AREAS ARE TO RECEIVE TILLED ORGANIC MATERIAL AT 4CY/1000SF. -SHREDDED CEDAR MULCH, RIVER ROCK AND COBBLESTONE AREAS (MINIMUM OF 3" DEPTH, (COLORS SELECTED BY OWNER) ARE TO BE UNDER -LAID WITH WEED BARRIER FABRIC. RECOMMENDED THAT ALL MULCH BEDS BE TURNED AND PREPPED ONCE ANNUALLY -GALVANIZED STEEL EDGING WILL BE INSTALLED AS BARRIER IN-BETWEEN SOD AND PLANTING BED AREAS. THE EDGING WILL BE SECURED WITH STEEL EDGING STAKES PENETRATING GRADE FOR SAFETY, AND INCLUDE PLASTIC SAFETY CAP OR ROLL-TOP. -POSITIVE DRAINAGE AWAY FROM BUILDING FOUNDATION TO REMAIN

- A MINIMUM 2% SLOPE IN BOTH SOFT AND HARD-SCAPE APPLICATIONS. ANY GRADE FOUND NOT TO BE WITHIN THESE MINIMUMS WILL BE THE RESPONSIBILITY OF THE OWNER.

-ALL RETAINING WALLS OVER 4 ARE TO BE ENGINEERED FOR PROPER WEIGHT LOAD DISTRIBUTION. ARE TO BE

ENGINEERED FOR PROPER WEIGHT LOAD DISTRIBUTION.

-ALL PLANTING AND SEEDING TO BE COMPLETED DURING THE ACTIVE GROWING SEASON, NOT DURING INCLEMENT OR FREEZING WEATHER.

-SOIL AMENDMENTS ARE REQUIRED FOR ALL PLANTED AREAS. ALL PLANT MATERIAL SHALL BE BACKFILLED WITH ONE PART COMPOST MIXTURE, TWO PARTS NATIVE TOPSOIL UPON AVAILABILITY.

-PLANTING MATERIAL TO BE NURSERY GROWN AND UP TO ANY AND ALL COLORADO PLANTING REGULATIONS OR GUIDELINES. —PLANTING MATERIAL DESIGN AND LAYOUT IS MERELY SUGGESTIVE, SPECIFIC VARIETIES, SPECIMENS, AND QUANTITIES TO BE DETERMINED DURING THE INSTALLATION PROCESS ACCORDING TO NURSERY STOCK AND

-BMP AND ALCA GUIDELINES FOR PROPER SELECTION, INSTALLATION AND MAINTENANCE ARE TO BE NOTED AND FOLLOWED DURING CONSTRUCTION. -ANY ELECTRICAL / PLUMBING / GAS / FENCING / CONCRETE / DECK OR OTHER CONTRACTING REQUIRED FOR LANDSCAPE CONSTRUCTION WILL BE THE RESPONSIBILITY OF THE OWNER. -LANDSCAPE CONTRACTOR IS RESPONSIBLE FOR LOCATION AND PRESERVATION OF ALL EXISTING UTILITIES PRIOR TO

BEGINNING WORK. CALL BEFORE YOU DIG: 1-800-922-1987. -LANDSCAPE CONTRACTOR IS RESPONSIBLE FOR FIELD VERIFYING ALL SITE CONDITIONS BEFORE BIDDING TO DETERMINE SCOPE OF WORK.

-ALL UTILITY EASEMENTS AND EMERGENCY ACCESSES SHALL REMAIN UNOBSTRUCTED AND FULLY ACCESSIBLE ALONG THEIR ENTIRE LENGTH FOR MAINTENANCE AND EMERGENCY EQUIPMENT AND VEHICLES.

TIERRA GARDEN CENTER LLC 801 WINONA CT. DENVER, CO 80204 PHONE: 720.938.3154

5 

KEY PLAN

\_\_\_

SEAL


SCALE


DRAWN APPROVED CHECKED DATE

SOUTH BLOCK


PROJECT NO.


SHEET NO.

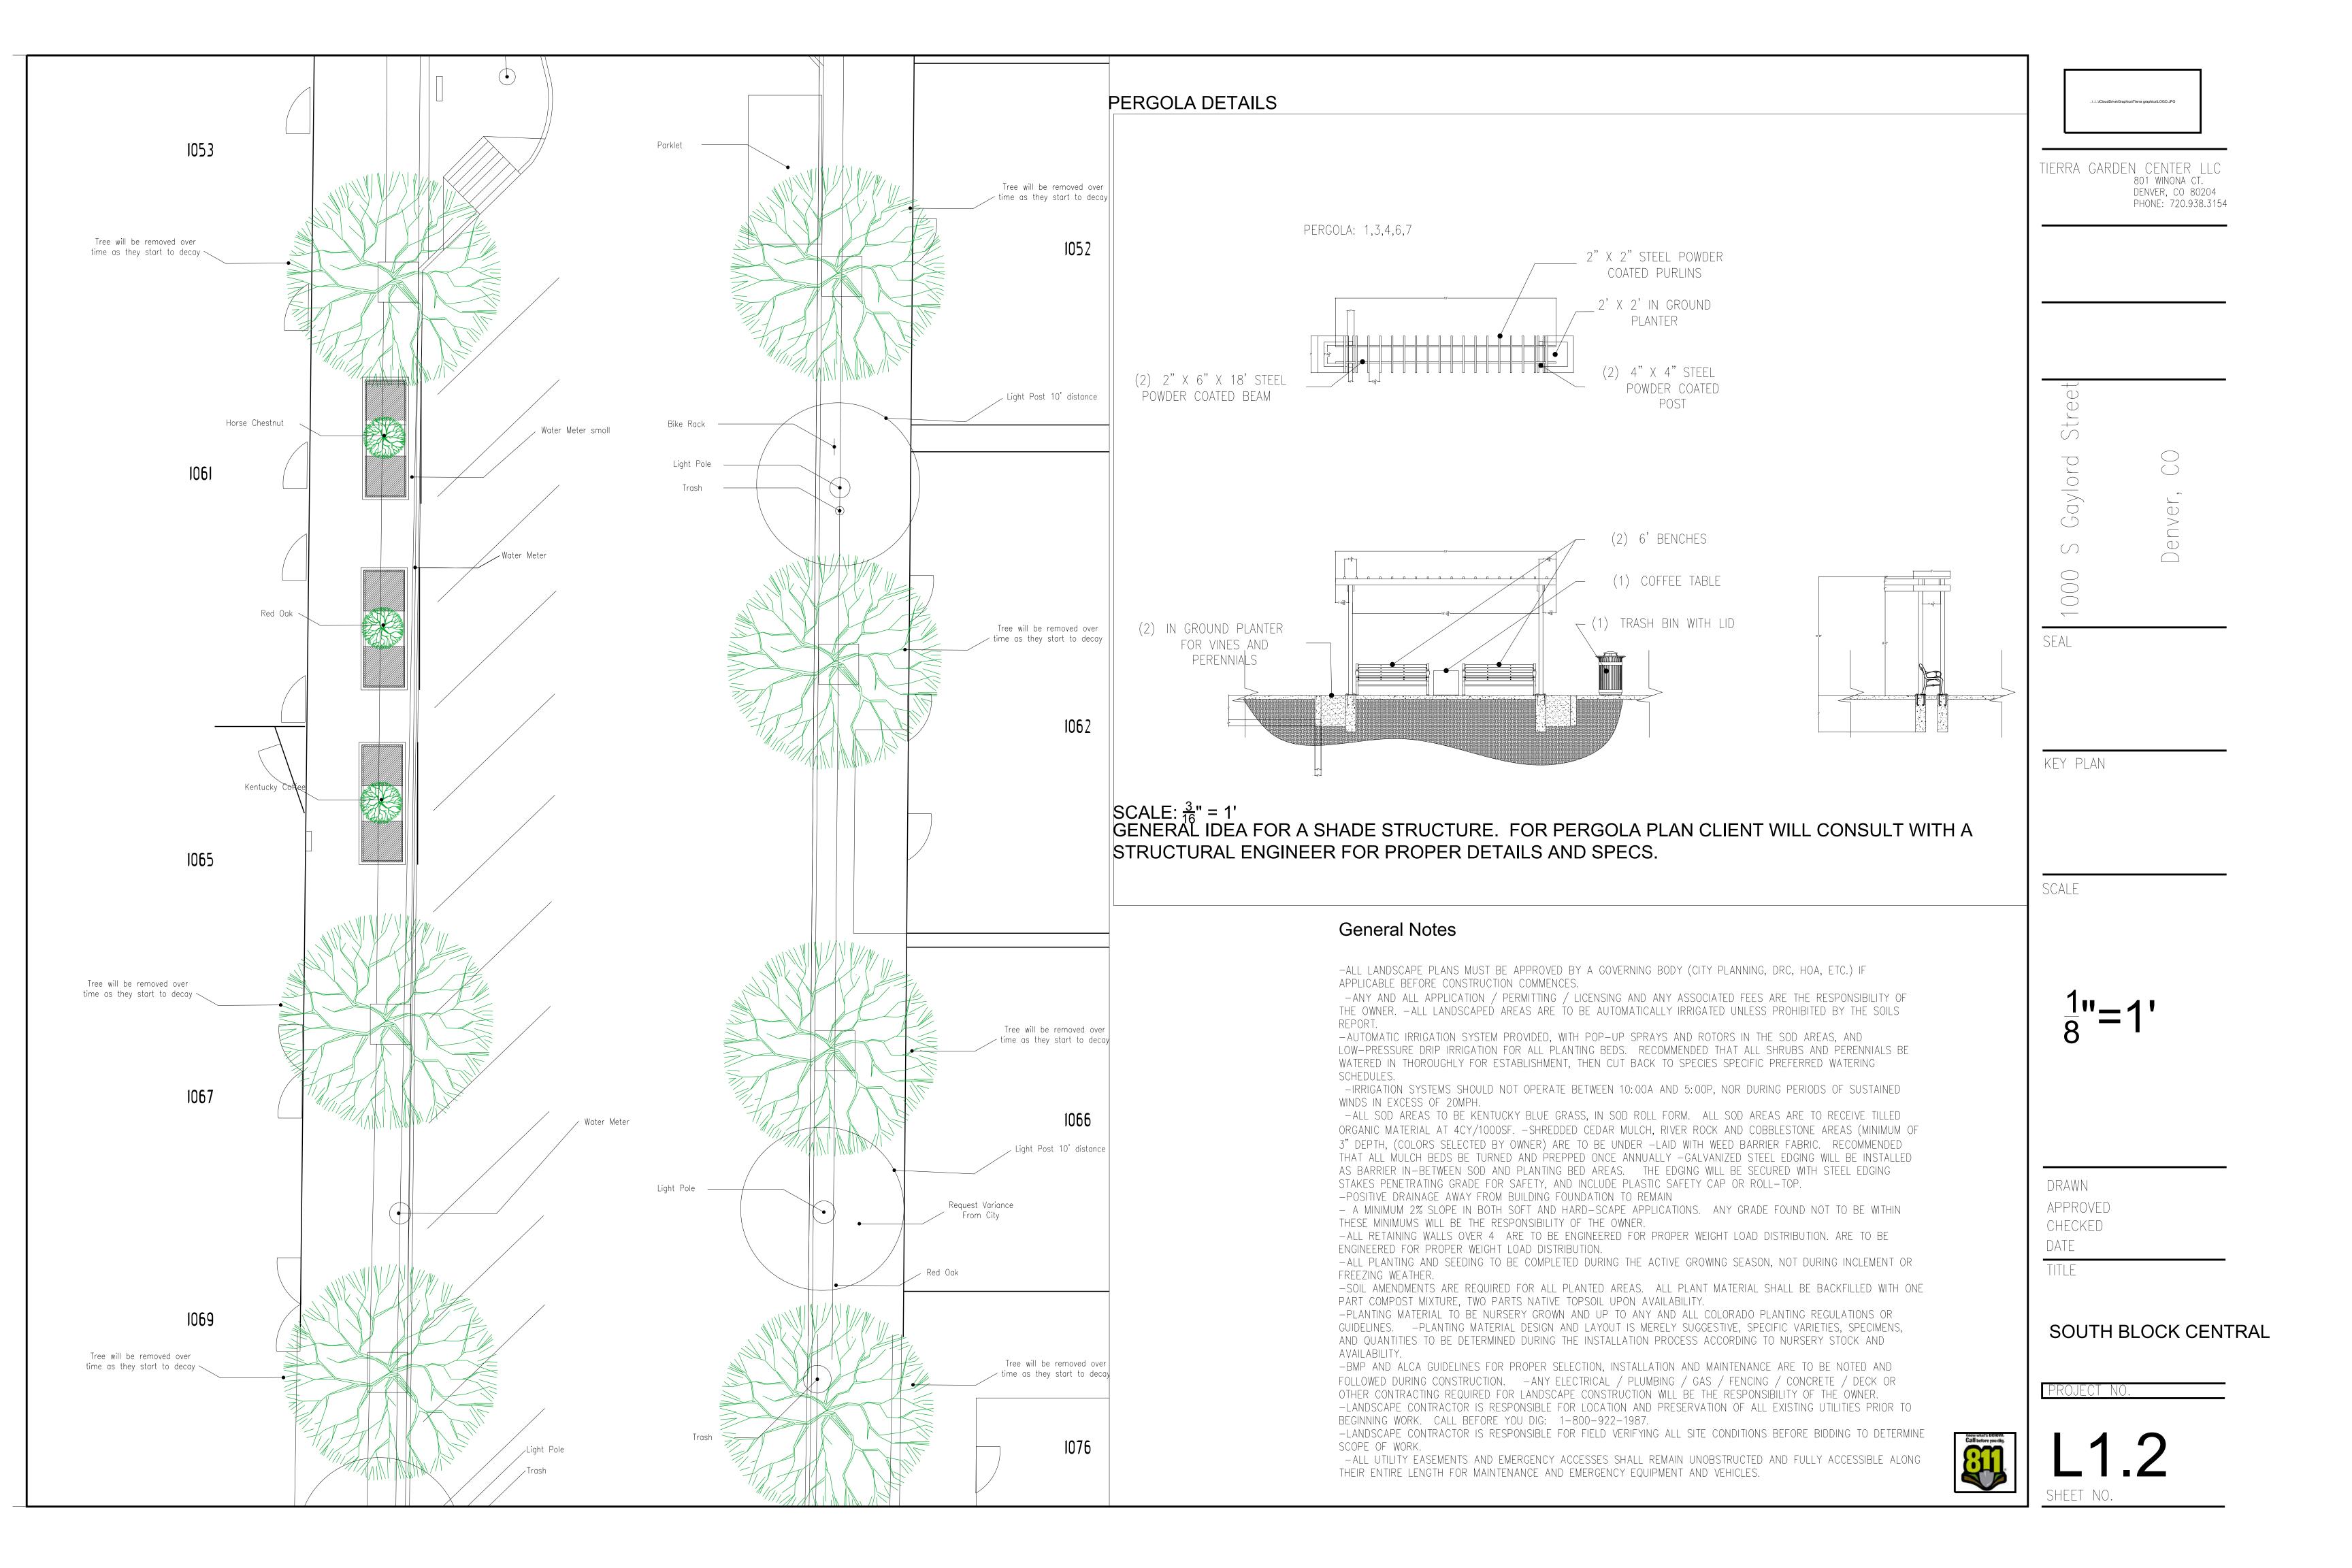


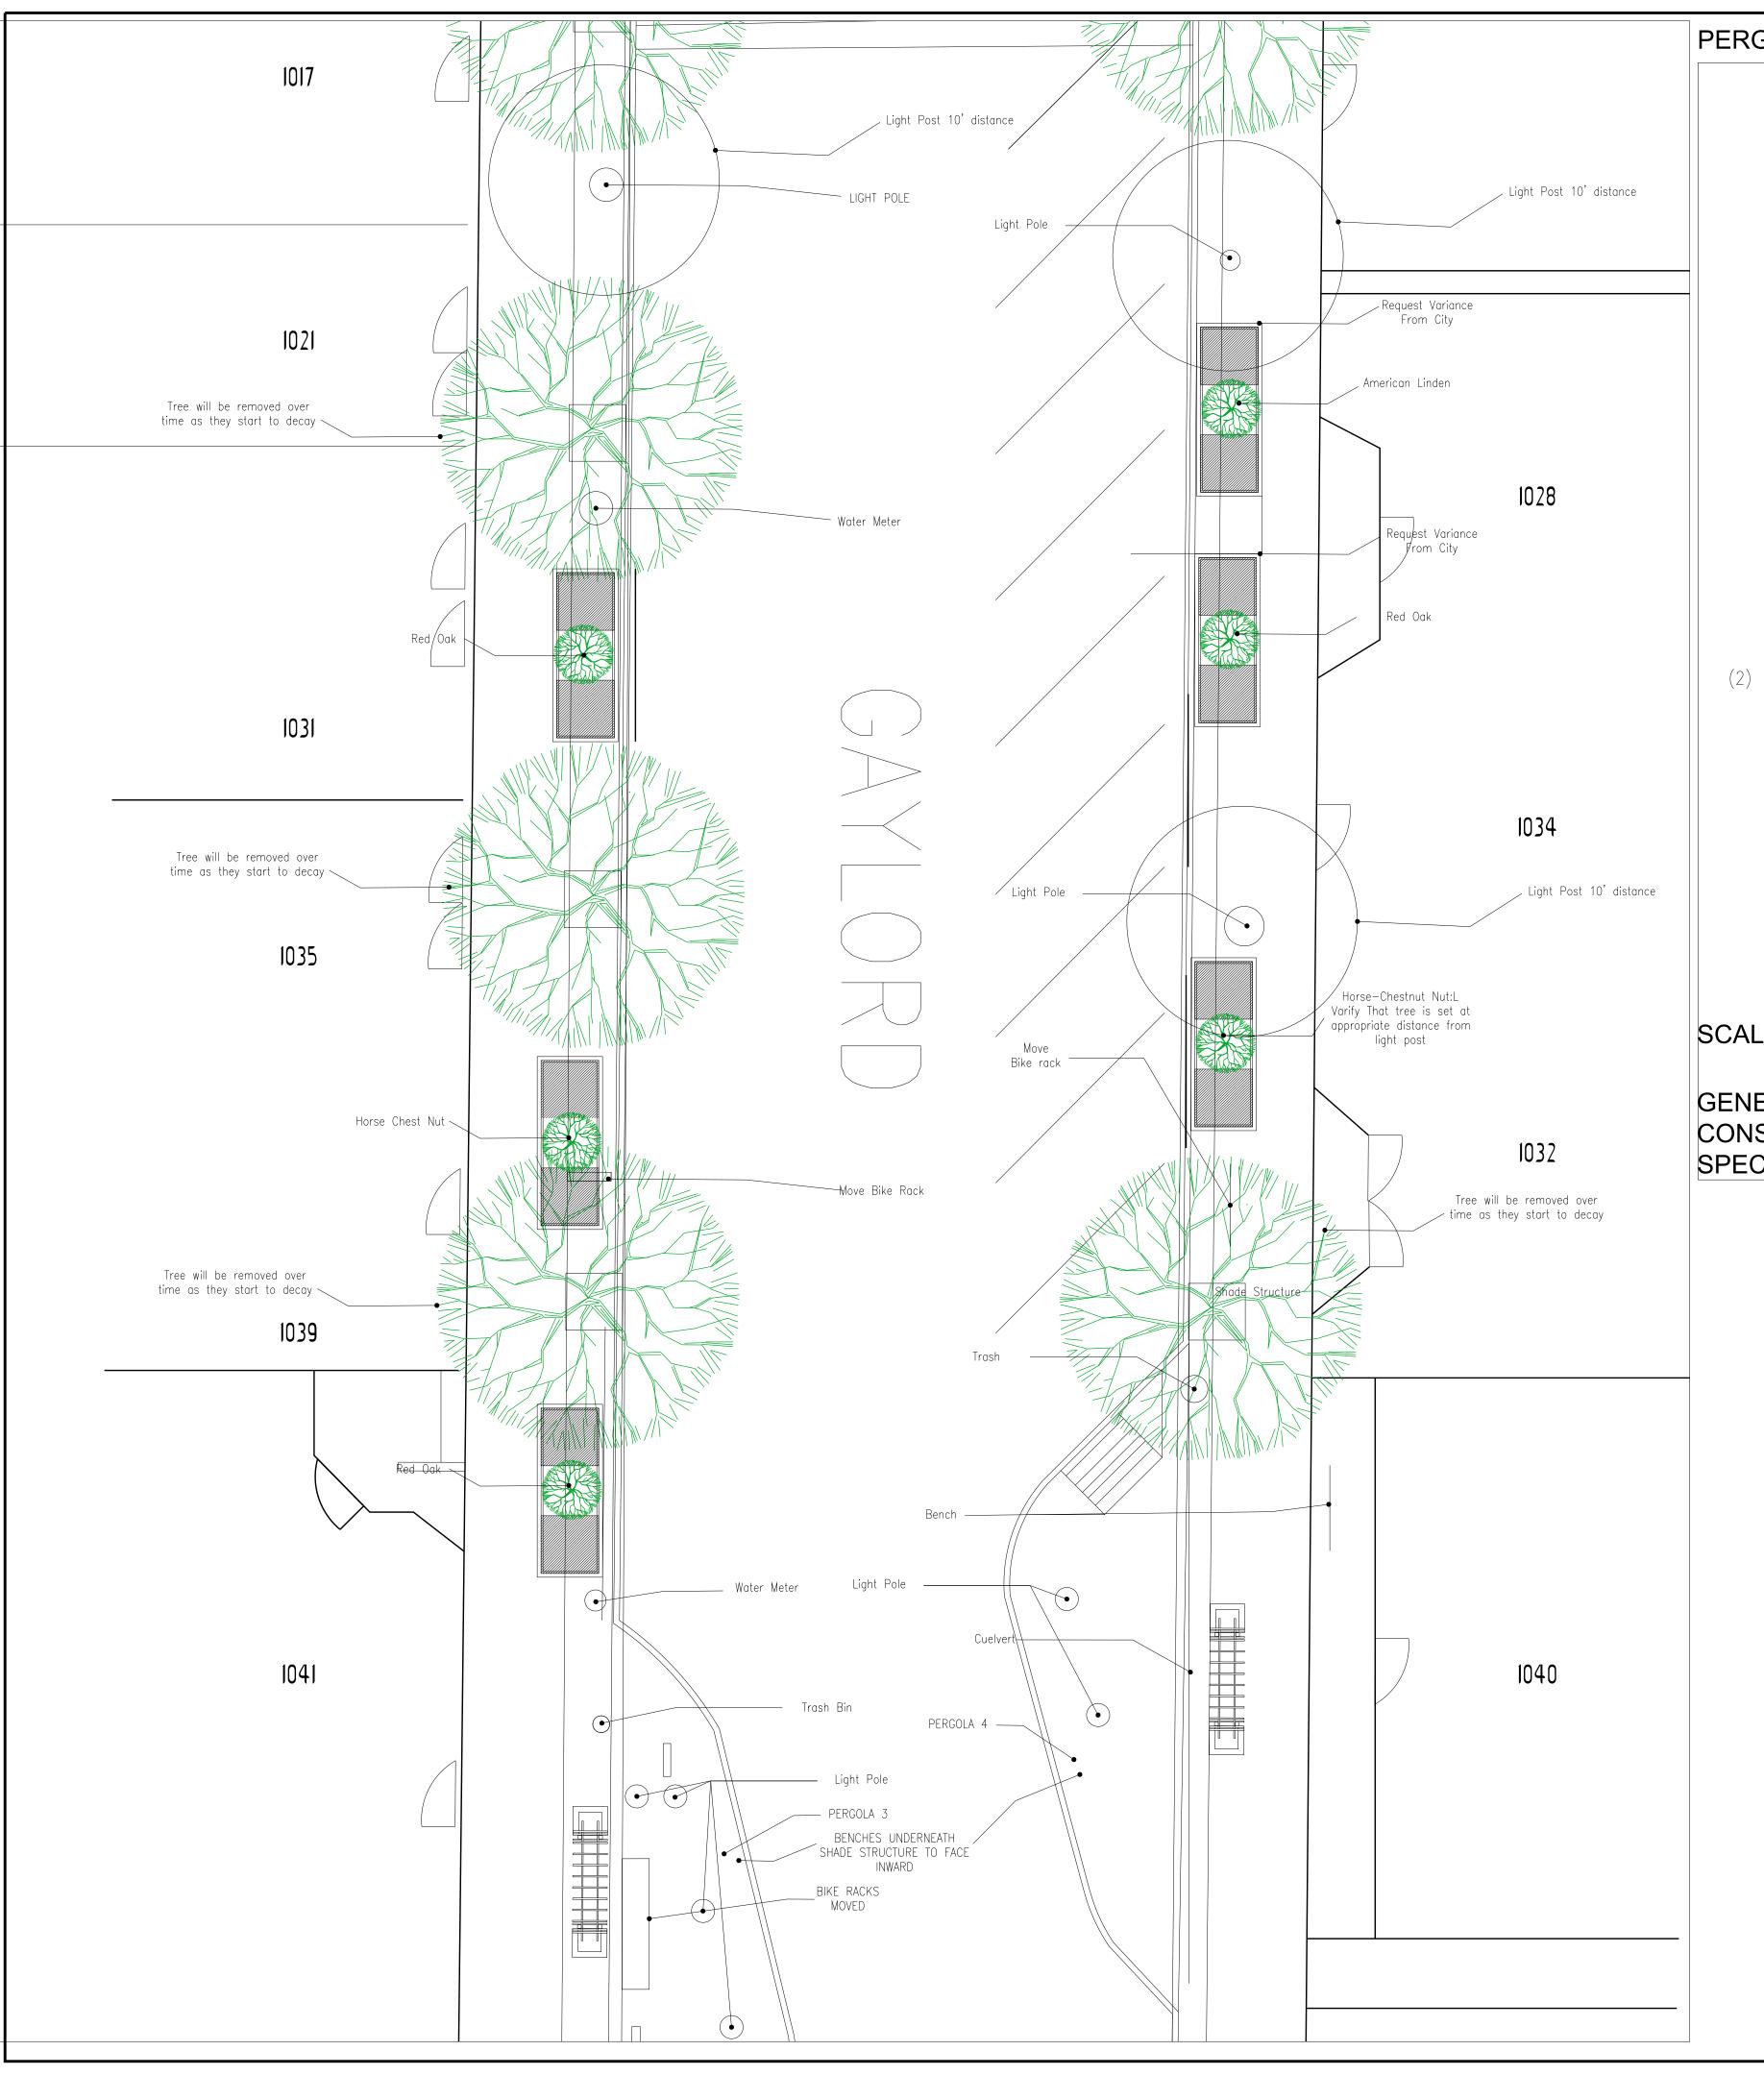

PERGOLA DETAILS

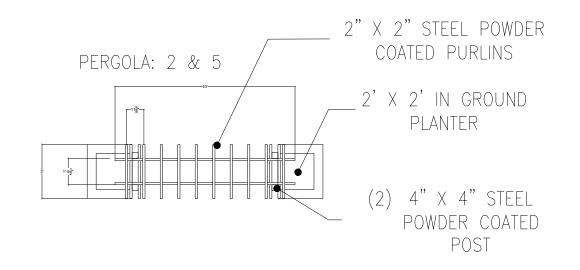

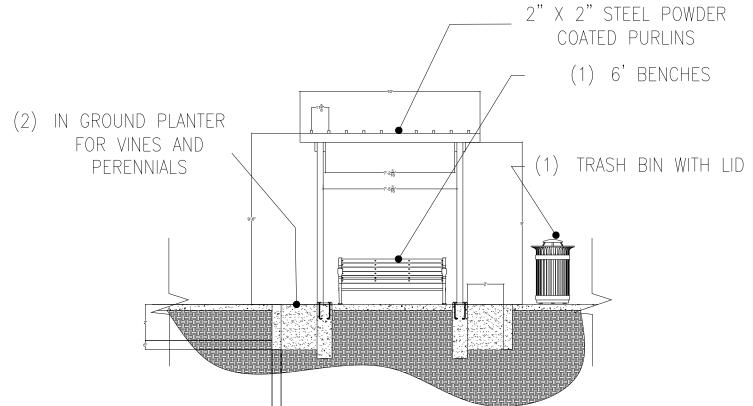

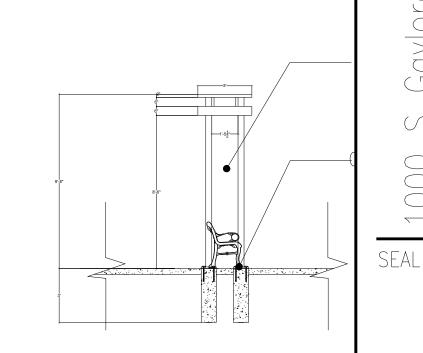

SCALE:  $\frac{3}{16}$ " = 1'

GENERAL IDEA FOR A SHADE STRUCTURE. FOR PERGOLA PLAN CLIENT WILL CONSULT WITH A STRUCTURAL ENGINEER FOR CALCULATED DETAILS AND SPECS.

# **General Notes**

-ALL LANDSCAPE PLANS MUST BE APPROVED BY A GOVERNING BODY (CITY PLANNING, DRC, HOA, ETC.) IF APPLICABLE BEFORE CONSTRUCTION COMMENCES.

-ANY AND ALL APPLICATION / PERMITTING / LICENSING AND ANY ASSOCIATED FEES ARE THE RESPONSIBILITY OF THE OWNER. -ALL LANDSCAPED AREAS ARE TO BE AUTOMATICALLY IRRIGATED UNLESS PROHIBITED BY THE SOILS REPORT.

-AUTOMATIC IRRIGATION SYSTEM PROVIDED, WITH POP-UP SPRAYS AND ROTORS IN THE SOD AREAS, AND LOW-PRESSURE DRIP IRRIGATION FOR ALL PLANTING BEDS. RECOMMENDED THAT ALL SHRUBS AND PERENNIALS BE WATERED IN THOROUGHLY FOR ESTABLISHMENT, THEN CUT BACK TO SPECIES SPECIFIC PREFERRED WATERING SCHEDULES

-IRRIGATION SYSTEMS SHOULD NOT OPERATE BETWEEN 10:00A AND 5:00P, NOR DURING PERIODS OF SUSTAINED WINDS IN EXCESS OF 20MPH.

-ALL SOD AREAS TO BE KENTUCKY BLUE GRASS, IN SOD ROLL FORM. ALL SOD AREAS ARE TO RECEIVE TILLED ORGANIC MATERIAL AT 4CY/1000SF. -SHREDDED CEDAR MULCH, RIVER ROCK AND COBBLESTONE AREAS (MINIMUM OF 3" DEPTH, (COLORS SELECTED BY OWNER) ARE TO BE UNDER -LAID WITH WEED BARRIER FABRIC. RECOMMENDED THAT ALL MULCH BEDS BE TURNED AND PREPPED ONCE ANNUALLY -GALVANIZED STEEL EDGING WILL BE INSTALLED AS BARRIER IN-BETWEEN SOD AND PLANTING BED AREAS. THE EDGING WILL BE SECURED WITH STEEL EDGING STAKES PENETRATING GRADE FOR SAFETY, AND INCLUDE PLASTIC SAFETY CAP OR ROLL-TOP. -POSITIVE DRAINAGE AWAY FROM BUILDING FOUNDATION TO REMAIN

- A MINIMUM 2% SLOPE IN BOTH SOFT AND HARD-SCAPE APPLICATIONS. ANY GRADE FOUND NOT TO BE WITHIN THESE MINIMUMS WILL BE THE RESPONSIBILITY OF THE OWNER.

-ALL RETAINING WALLS OVER 4 ARE TO BE ENGINEERED FOR PROPER WEIGHT LOAD DISTRIBUTION. ARE TO BE ENGINEERED FOR PROPER WEIGHT LOAD DISTRIBUTION.

-ALL PLANTING AND SEEDING TO BE COMPLETED DURING THE ACTIVE GROWING SEASON, NOT DURING INCLEMENT OR FREEZING WEATHER.
-SOIL AMENDMENTS ARE REQUIRED FOR ALL PLANTED AREAS. ALL PLANT MATERIAL SHALL BE BACKFILLED WITH ONE

PART COMPOST MIXTURE, TWO PARTS NATIVE TOPSOIL UPON AVAILABILITY.

-PLANTING MATERIAL TO BE NURSERY GROWN AND UP TO ANY AND ALL COLORADO PLANTING REGULATIONS OR GUIDELINES.

-PLANTING MATERIAL DESIGN AND LAYOUT IS MERELY SUGGESTIVE, SPECIFIC VARIETIES, SPECIMENS, AND QUANTITIES TO BE DETERMINED DURING THE INSTALLATION PROCESS ACCORDING TO NURSERY STOCK AND

AVAILABILITY.

-BMP AND ALCA GUIDELINES FOR PROPER SELECTION, INSTALLATION AND MAINTENANCE ARE TO BE NOTED AND FOLLOWED DURING CONSTRUCTION.

-ANY ELECTRICAL / PLUMBING / GAS / FENCING / CONCRETE / DECK OR OTHER CONTRACTING REQUIRED FOR LANDSCAPE CONSTRUCTION WILL BE THE RESPONSIBILITY OF THE OWNER.

-LANDSCAPE CONTRACTOR IS RESPONSIBLE FOR LOCATION AND PRESERVATION OF ALL EXISTING UTILITIES PRIOR TO

BEGINNING WORK. CALL BEFORE YOU DIG: 1-800-922-1987.

-LANDSCAPE CONTRACTOR IS RESPONSIBLE FOR FIELD VERIFYING ALL SITE CONDITIONS BEFORE BIDDING TO DETERMINE SCOPE OF WORK

-ALL UTILITY EASEMENTS AND EMERGENCY ACCESSES SHALL REMAIN UNOBSTRUCTED AND FULLY ACCESSIBLE ALONG THEIR ENTIRE LENGTH FOR MAINTENANCE AND EMERGENCY EQUIPMENT AND VEHICLES.



TIERRA GARDEN CENTER LLC 801 WINONA CT. DENVER, CO 80204 PHONE: 720.938.3154

1000 S Gaylord Street
Denver, CO

KEY PLAN

SCALE


 $\frac{1}{8}$ "=1

DRAWN
APPROVED
CHECKED
DATE


NORTH CENTRAL BLOCK

PROJECT NO.

L1.3

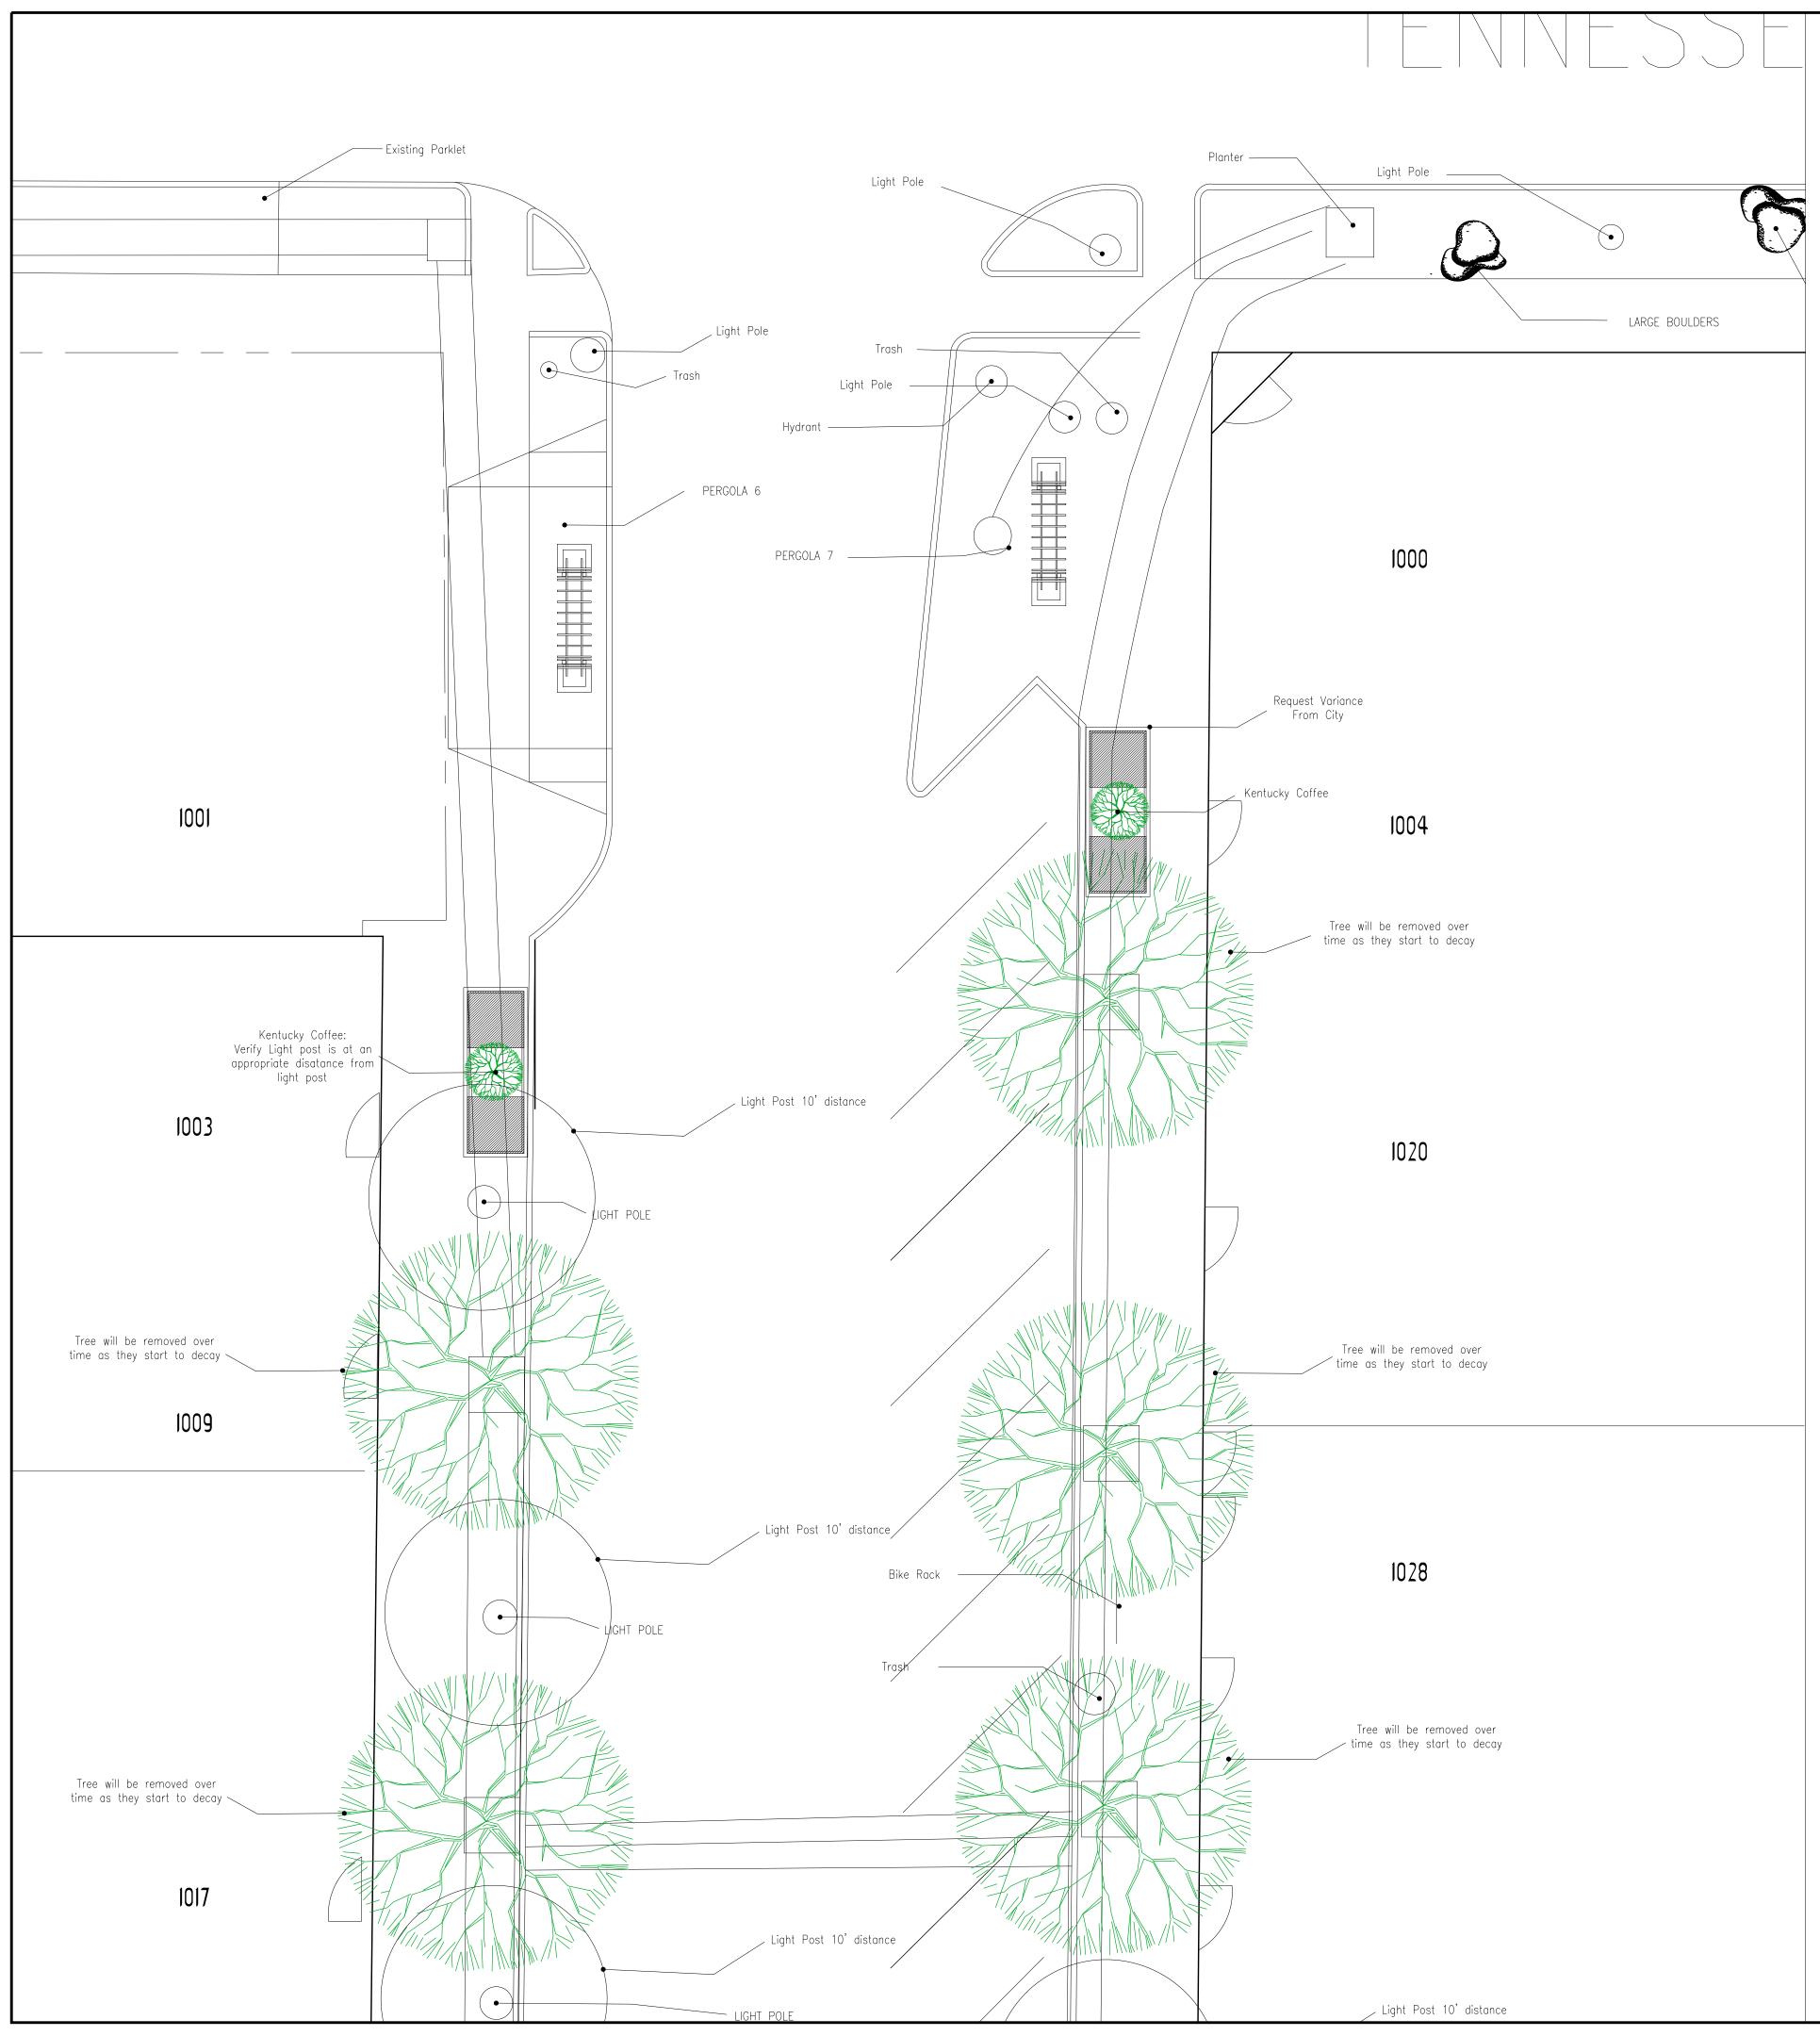

### LANDSCAPE FURNITURE.

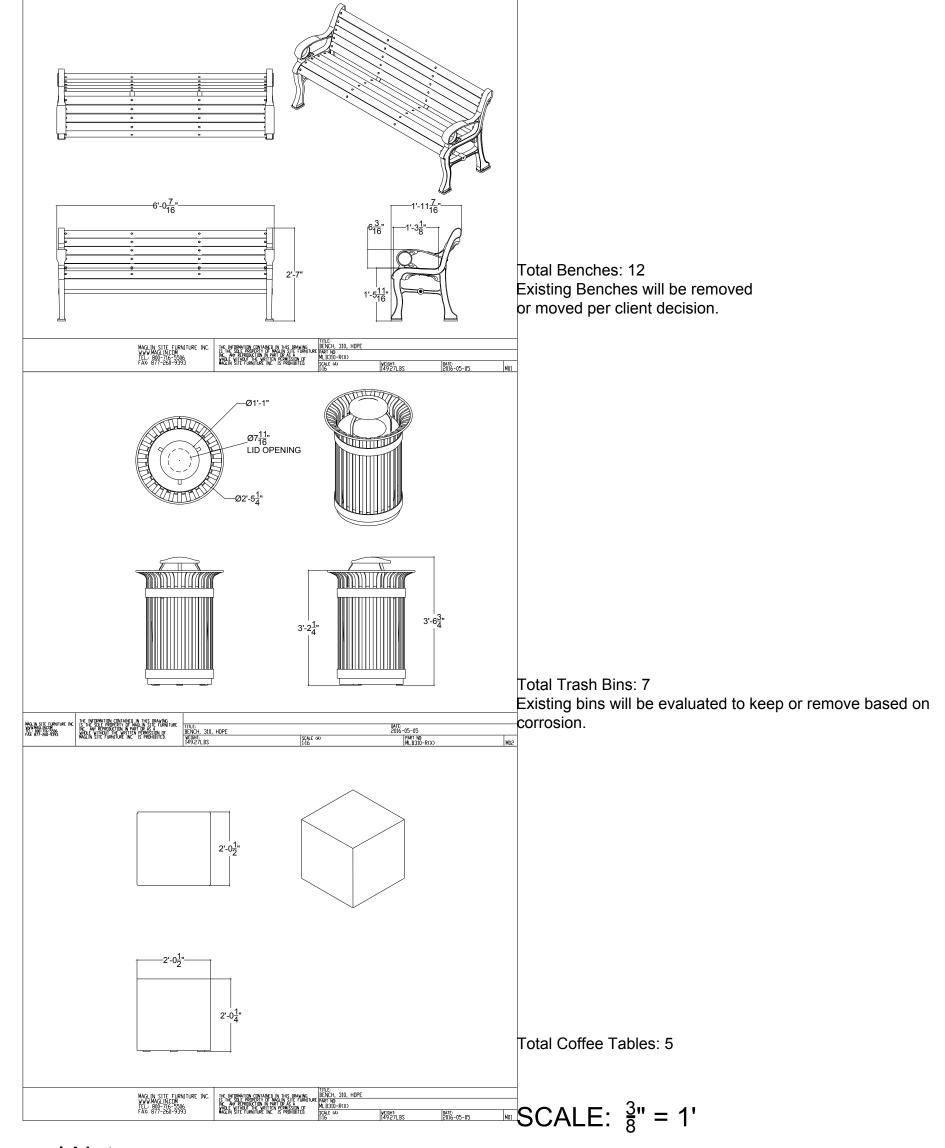

# **General Notes**

-ALL LANDSCAPE PLANS MUST BE APPROVED BY A GOVERNING BODY (CITY PLANNING, DRC, HOA, ETC.) IF APPLICABLE BEFORE CONSTRUCTION COMMENCES.

-ANY AND ALL APPLICATION / PERMITTING / LICENSING AND ANY ASSOCIATED FEES ARE THE RESPONSIBILITY OF THE OWNER. -ALL LANDSCAPED AREAS ARE TO BE AUTOMATICALLY IRRIGATED UNLESS PROHIBITED BY THE SOILS REPORT.

-AUTOMATIC IRRIGATION SYSTEM PROVIDED, WITH POP-UP SPRAYS AND ROTORS IN THE SOD AREAS, AND LOW-PRESSURE DRIP IRRIGATION FOR ALL PLANTING BEDS. RECOMMENDED THAT ALL SHRUBS AND PERENNIALS BE WATERED IN THOROUGHLY FOR ESTABLISHMENT, THEN CUT BACK TO SPECIES SPECIFIC PREFERRED WATERING SCHEDULES

-IRRIGATION SYSTEMS SHOULD NOT OPERATE BETWEEN 10:00A AND 5:00P, NOR DURING PERIODS OF SUSTAINED WINDS IN EXCESS OF 20MPH.

-ALL SOD AREAS TO BE KENTUCKY BLUE GRASS, IN SOD ROLL FORM. ALL SOD AREAS ARE TO RECEIVE TILLED ORGANIC MATERIAL AT 4CY/1000SF. -SHREDDED CEDAR MULCH, RIVER ROCK AND COBBLESTONE AREAS (MINIMUM OF 3" DEPTH, (COLORS SELECTED BY OWNER) ARE TO BE UNDER -LAID WITH WEED BARRIER FABRIC. RECOMMENDED THAT ALL MULCH BEDS BE TURNED AND PREPPED ONCE ANNUALLY -GALVANIZED STEEL EDGING WILL BE INSTALLED AS BARRIER IN-BETWEEN SOD AND PLANTING BED AREAS. THE EDGING WILL BE SECURED WITH STEEL EDGING STAKES PENETRATING GRADE FOR SAFETY, AND INCLUDE PLASTIC SAFETY CAP OR ROLL-TOP. -POSITIVE DRAINAGE AWAY FROM BUILDING FOUNDATION TO REMAIN

- A MINIMUM 2% SLOPE IN BOTH SOFT AND HARD-SCAPE APPLICATIONS. ANY GRADE FOUND NOT TO BE WITHIN THESE MINIMUMS WILL BE THE RESPONSIBILITY OF THE OWNER.

-ALL RETAINING WALLS OVER 4 ARE TO BE ENGINEERED FOR PROPER WEIGHT LOAD DISTRIBUTION. ARE TO BE

ENGINEERED FOR PROPER WEIGHT LOAD DISTRIBUTION.

-ALL PLANTING AND SEEDING TO BE COMPLETED DURING THE ACTIVE GROWING SEASON, NOT DURING INCLEMENT OR FREEZING WEATHER.

-SOIL AMENDMENTS ARE REQUIRED FOR ALL PLANTED AREAS. ALL PLANT MATERIAL SHALL BE BACKFILLED WITH ONE

PART COMPOST MIXTURE, TWO PARTS NATIVE TOPSOIL UPON AVAILABILITY.

-PLANTING MATERIAL TO BE NURSERY GROWN AND UP TO ANY AND ALL COLORADO PLANTING REGULATIONS OR
GUIDELINES -PLANTING MATERIAL DESIGN AND LAYOUT IS MERELY SUGGESTIVE SPECIFIC VARIETIES SPECIMENS

—PLANTING MATERIAL TO BE NURSERY GROWN AND UP TO ANY AND ALL COLORADO PLANTING REGULATIONS OR GUIDELINES. —PLANTING MATERIAL DESIGN AND LAYOUT IS MERELY SUGGESTIVE, SPECIFIC VARIETIES, SPECIMENS, AND QUANTITIES TO BE DETERMINED DURING THE INSTALLATION PROCESS ACCORDING TO NURSERY STOCK AND AVAILABILITY.

-BMP AND ALCA GUIDELINES FOR PROPER SELECTION, INSTALLATION AND MAINTENANCE ARE TO BE NOTED AND FOLLOWED DURING CONSTRUCTION. -ANY ELECTRICAL / PLUMBING / GAS / FENCING / CONCRETE / DECK OR OTHER CONTRACTING REQUIRED FOR LANDSCAPE CONSTRUCTION WILL BE THE RESPONSIBILITY OF THE OWNER. -LANDSCAPE CONTRACTOR IS RESPONSIBLE FOR LOCATION AND PRESERVATION OF ALL EXISTING UTILITIES PRIOR TO BEGINNING WORK. CALL BEFORE YOU DIG: 1-800-922-1987.

-LANDSCAPE CONTRACTOR IS RESPONSIBLE FOR FIELD VERIFYING ALL SITE CONDITIONS BEFORE BIDDING TO DETERMINE SCOPE OF WORK.

-ALL UTILITY EASEMENTS AND EMERGENCY ACCESSES SHALL REMAIN UNOBSTRUCTED AND FULLY ACCESSIBLE ALONG THEIR ENTIRE LENGTH FOR MAINTENANCE AND EMERGENCY EQUIPMENT AND VEHICLES.




TIERRA GARDEN CENTER LLC 801 WINONA CT. DENVER, CO 80204 PHONE: 720.938.3154

000 S Gaylord Street
Denver, CO

KEY PLAN

SCALE

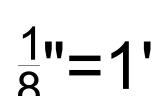


DRAWN
APPROVED
CHECKED
DATE


NORTH BLOCK


PROJECT NO.


L1.4



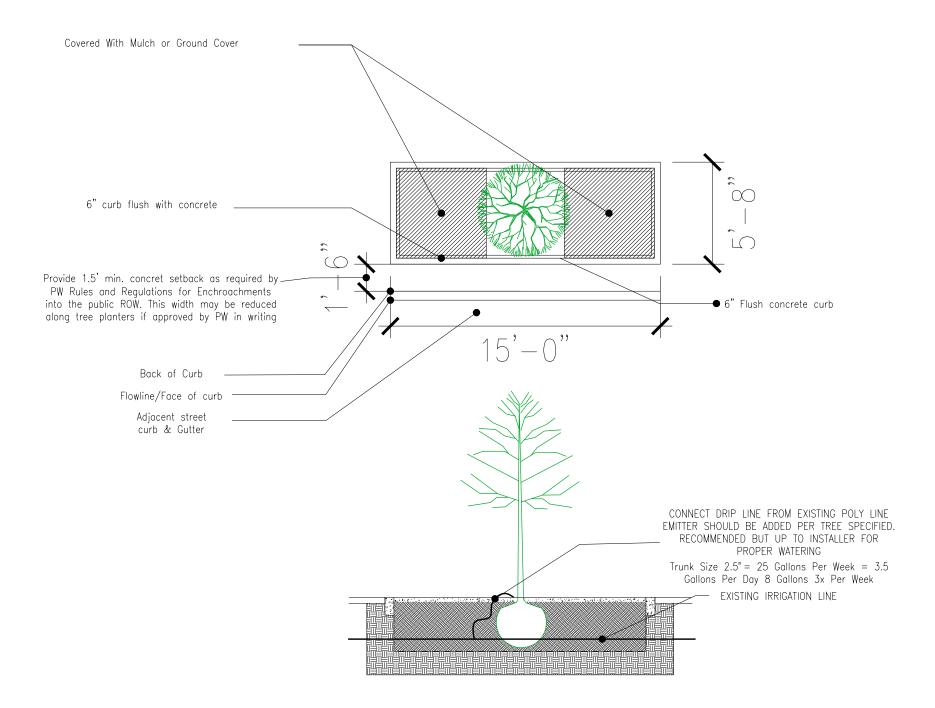

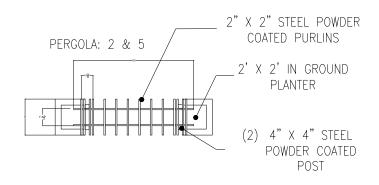

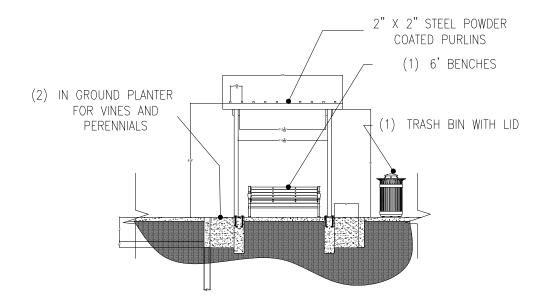

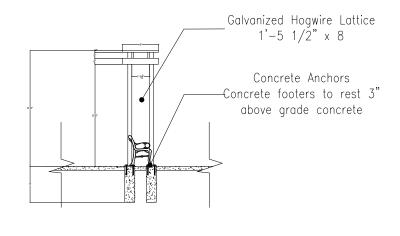

SCALE:  $\frac{1}{8}$ " = 1'